HUEY P. LONG AVE. STREET LIGHTING 2ND TO 5TH STREETS

FOR THE CITY OF GRETNA, LOUISIANA



MAYOR BELINDA C. CONSTANT

COUNCIL MEMBERS


WAYNE A. RAU—COUNCILMAN AT—LARGE
RUDY S. SMITH — COUNCILMAN DISTRICT 1
MICHAEL A. HINYUB — COUNCILMAN DISTRICT 2
MARK K. MILLER — COUNCILMAN DISTRICT 3
JACKIE J. BERTHELOT — COUNCILMAN DISTRICT 4

INDEX OF DRAWINGS


T1	TITLE SHEET
E1.0	SCHEDULES AND NOTES
E2.0	SCHEDULES AND ABBREVIATION
E3.0	KEY PLAN
E3.1	LIGHTING PLAN
E3.2	LIGHTING PLAN
E3.3	LIGHTING PLAN
E4.0	ELECTRICAL TYPICAL DETAILS
E4.1	ELECTRICAL TYPICAL DETAILS
E4.2	ELECTRICAL ONE-LINE
E4.3	ELECTRICAL ONE-LINE
E4.4	ELECTRICAL PANEL SCHEDULE
E5.0	ELECTRICAL DETAILS
E5.1	ELECTRICAL DETAILS
E5.2	ELECTRICAL DETAILS



BKI PROJECT NO. 9344-8350 DECEMBER 2024

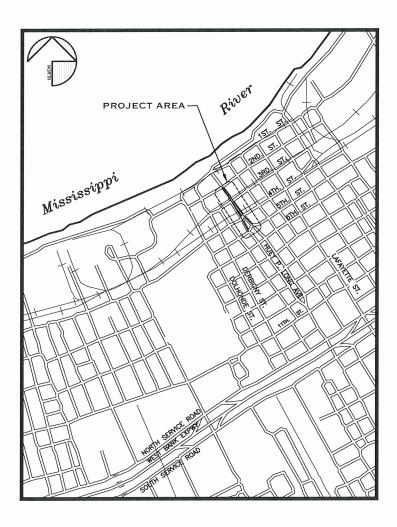

LOCATION MAP

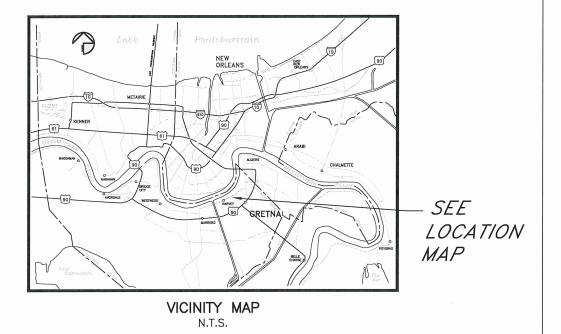

APPROVAL

2/24/25

David Boyd PE, DATE

VICE PRESIDENT, BURK-KLEINPETER, INC.

BELINDA C. CONSTANT, MAYOR
CITY OF GRETNA, LOUISIANA

DATE



CALL BEFORE YOU DIG: Always dial 811 or 800 272-3020 first. The call and the service are FREE.

SYMBOL SCHEDULE


	SIMBUL SCHEDULE
	LIGHTING SYMBOLS
	DESCRIPTION
•	POST TOP LUMINAIRE. LETTER DENOTES LUMINAIRE TYPE. SEE LUMINAIRE SCHEDULE.
	POWER SYMBOLS
	DESCRIPTION
	DISCONNECT SWITCH. FUSED UNLESS OTHERWISE NOTED.
U O	JUNCTION BOX.
	TRANSFORMER
	WIRING SYMBOLS
	DESCRIPTION
	WIRING (IN CONDUIT) RUN EXPOSED.
UG _	WIRING UNDERGROUND (SITE WORK).
OHP	WIRING OVERHEAD (SITE WORK).
	, ,
S	SEWER LINE.
	DRAIN LINE.
	WATER LINE.
L:1,3	HOMERUN TO PANELBOARD WITH NOMENCLATURE (LETTERS), CIRCUIT NUMBERS (NUMBERS), NUMBER OF CIRCUITS (NUMBER OF ARROWS), EACH CIRCUIT TO HAVE GROUND.
	GROUND CONNECTION
-0	CONDUIT TURNED UP.
	CONDUIT TURNED DOWN.
	CONDUIT STUBBED OUT.
	PULL BOX. NEMA CONFIGURATION AS NOTED.
	6" SCH. 80 PVC CONDUIT 'CASING' (UNDERGROUND) WITH 2" PVC CONDUIT AND CONDUCTORS AS INDICATED
	ONE-LINE SYMBOLS
	DESCRIPTION
M	METER ENCLOSURE.
M	METER.
000	CIRCUIT BREAKER.
0	SWITCH, SINGLE POLE—SINGLE THROW.
	FUSE.
	FUSED SWITCH.
38	DRY TYPE TRANSFORMER.
•	EXOTHERMIC WELD CONNECTION

	REFERENCE SYMBOLS							
	DESCRIPTION							
1	REFERENCE NOTE.							
1	SPECIFIC NOTE REFERENCE.							
1	CALL OUT REFERENCE.							
1	REVISION REFERENCE.							
A E1 E2	DETAIL REFERENCE: "A" DENOTES DETAIL "E1" DENOTES SHEET NUMBER WHERE DETAIL IS TAKEN "E2" DENOTES SHEET NUMBER WHERE DETAIL IS DRAWN							
MISC. SYMBOLS								
	DESCRIPTION							
X	TO BE REMOVED							

GENERAL NOTES:

- 1. ALL WIRING, DUCT LINE CONDUIT, APPARATUS, DEVICES, LUMINAIRES, EQUIPMENT AND FOUNDATIONS SHALL CONFORM TO CITY OF GRETNA REQUIREMENTS, APPLICABLE ORDINANCES OR RESOLUTIONS AND THEIR STANDARD DETAILS FOR CONSTRUCTION OF SAME. ALL WIRING SHALL BE IN CONDUIT.
- 2. THE CONTRACTOR SHALL SECURE ALL PERMITS FOR HIS WORK AND ARRANGE FOR ALL INSPECTIONS REQUIRED.
- 3. THE CONTRACTOR SHALL FURNISH ALL LABOR, MATERIALS AND EQUIPMENT REQUIRED TO CONSTRUCT A COMPLETE SYSTEM AS SHOWN IN THE PLANS AND AS COMPLYING WITH CITY OF GRETNA REQUIREMENTS.
- 4. THE CONTRACTOR SHALL SECURE APPROVALS FOR THE WORK IN WRITING FROM THE CITY OF GRETNA AND SHALL PRESENT THE APPROVAL TO THE OWNER BEFORE FINAL PAYMENT.
- 5. THE LOCATION SHOWN ON PLANS OF EXISTING UTILITIES IS APPROXIMATE. THE CONTRACTOR SHALL CAREFULLY VERIFY THESE LOCATIONS AND TAKE WHATEVER PRECAUTIONS NECESSARY TO AVOID DAMAGE TO EXISTING UTILITIES.
- 6. THE CONTRACTOR WILL BE REQUIRED TO FURNISH THE OWN CONSTRUCTION LAYOUT FOR THE STREET LIGHT STANDARDS.
- 7. CITY OF GRETNA HAS EXAMINED THE LOCATION OF THE STREET LIGHT FOUNDATIONS AND APPROVES OF THESE LOCATIONS. IT IS HEREBY UNDERSTOOD THAT CITY OF GRETNA RESERVES THE RIGHT TO REQUIRE RELOCATION OF SAID STREET LIGHT FOUNDATIONS, THE SAME ARE TO BE RELOCATED AT THE COST AND EXPENSE OF THE PARTY DESIRING RELOCATION. ALL RELOCATION OF STREET LIGHTS MUST HAVE THE PRIOR APPROVAL OF CITY OF GRETNA.
- 8. ALL UTILITIES SHALL MEET WITH THE REQUIREMENTS OF THE LOCAL UTILITY PROVIDER AND SHALL ALSO COMPLY WITH ALL GROUNDING REQUIREMENTS AS SPECIFIED BY THE PLANS, SPECIFICATIONS, AND THE 2020 NATIONAL ELECTRICAL CODE (N.E.C.)
- 9. ALL CONDUIT FOR STREET LIGHTING SYSTEMS WHERE EXPOSED SHALL BE GALVANIZED RIGID STEEL CONDUIT.
- 10. EQUIPMENT AND MATERIAL SHALL NOT BE ORDERED OR INSTALLED UNTIL IT IS APPROVED BY THE ENGINEER.
- 11. EQUIPMENT AND RACEWAY LAYOUTS ARE DIAGRAMMATIC, AND THEY DO NOT SHOW EXACT LOCATIONS. THE EXACT LOCATIONS OF LIGHT POLES, CONDUITS, JUNCTION BOXES, ETC., SHALL BE AS DIRECTED BY THE PROJECT ENGINEER. THE CONTRACTOR SHALL FURNISH AS—BUILT DRAWINGS WHICH SHOW THE FINAL INSTALLED LOCATIONS OF THE EQUIPMENT.
- 12. ALL SUPPORT MATERIALS, INCLUDING FASTENERS AND HARDWARE, SHALL BE HOT DIP GALVANIZED OR STAINLESS STEEL.
- 13. ALL EXPOSED CONDUIT FITTINGS AND COUPLINGS SHALL BE THREADED SCREW TYPE. THREADLESS, COMPRESSION, OR SPLIT BOLT ON COUPLINGS ARE NOT ACCEPTABLE.
- 14. THE CONTRACTOR SHALL MAINTAIN PROPER CLEARANCES FROM ALL OVERHEAD AND UNDERGROUND UTILITIES, AND SHALL CONTACT EACH UTILITY FOR SPECIFIC REQUIREMENTS. NEW ELECTRICAL SHALL BE ROUTED UNDER EXISTING UTILITY.
- 15. THE CONTRACTOR PER THE DIRECTION OF CITY OF GRETNA SHALL USE THE EXPLORATORY ITEM TO DETERMINE THE EXACT LOCATION AND DEPTH OF EXISTING CITY/PARISH UTILITIES AND POTENTIAL CONFLICTS. ALL EXCAVATION FOR THIS ITEM SHALL BE IN THE PRESENCE OF A REPRESENTATIVE OF CITY OF GRETNA DEPARTMENT OF PUBLIC UTILITIES.
- 16. THE CONTRACTOR IS RESPONSIBLE FOR SATISFACTORILY MAINTAINING THE IMMEDIATE WORK AREA IN A NEAT AND ORDERLY MANNER.
- 17. FOUNDATIONS FOR STREET LIGHT STANDARDS SHALL BE AS DETAILED IN THE DRAWINGS.
- 18. UNLESS OTHERWISE NOTED, ALL UNDERGROUND RACEWAY SHALL BE PVC/HDPE SCHEDULE 40 CONDUIT BURIED AT MINIMUM 24" BELOW FINISHED GRADE.
- 19. A COPPER WELD GROUND ROD MINIMUM 10' X 5/8" DIAMETER WILL BE REQUIRED AT EACH POLE FOUNDATION WITH #6 CU RHW GROUND CONDUCTOR.
- 20. THE PLANS DO NOT NECESSARILY SHOW ALL UNDERGROUND FACILITIES. BEFORE BEGINNING EXCAVATION, THE CONTRACTOR SHALL CHECK THE AREA FOR EVIDENCE OF UNDERGROUND FACILITIES.

- 21. ALL UNDERGROUND RACEWAY FOR STREET LIGHTING SYSTEMS WHEN RUN UNDER UNDEVELOPED OR NEWLY CUT STREETS (NOT YET PAVED, BLACKTOPPED, OR GRAVELED) THEY SHALL BE NON-METALLIC PVC SCHEDULE 40 (OR BETTER) ENCASED IN CONCRETE AND THROUGH A SIX INCH (6") CONDUIT UNDER SAID STREET. AN "E" SHALL BE ETCHED IN THE CURB AT ANY AND ALL ELECTRICAL CROSSINGS UNDER STREETS. ALL RACEWAYS SHALL HAVE A MINIMUM TRADE SIZE OF 1 INCH (1") AND BE BURIED A MINIMUM OF TWENTY-FOUR INCHES (24") BELOW GRADE. WHERE THE RACEWAY RISES UP TO THE LIGHT STANDARDS, IT MUST COME ABOVE THE FOUNDATION A MINIMUM OF 4 INCHES (4"). ALL ELBOWS OR BENDS USED IN THE SYSTEM SHALL BE 1-INCH (1") MINIMUM PVC SCHEDULE 40 (OR BETTER).
- 22. STREET LIGHT FOUNDATIONS SHALL BE OF CONCRETE CAST IN PLACE TO BE IN ACCORDANCE WITH THE TYPICAL FOUNDATION PLAN FOR STREET LIGHT STANDARDS FOR CITY OF GRETNA DEPARTMENT OF PUBLIC UTILITIES.
- 23. ALL STREET LIGHT FOUNDATION AND BOX INSTALLATION SHALL AVOID CONFLICTS WITH HANDICAPPED ACCESSIBILITY RAMPS AND THE LOCATION OF THESE RAMPS WILL GOVERN THE EXACT LOCATION OF THE STREETLIGHT FOUNDATIONS AND BOXES. PRIOR TO INSTALLATION, THE CONTRACTOR SHALL COORDINATE THEIR ACTIVITIES WITH THE CITY OF GRETNA PROJECT MANAGER.
- 24. STREET LIGHT SYSTEM WILL BE SERVED FROM ENTERGY, INC. FEED POINT.
- 25. THE CONTRACTOR SHALL SUPPLY AND MAINTAIN CONSTRUCTION SIGNS (IF REQUIRED BY THE CITY OF GRETNA DEPARTMENT OF PUBLIC UTILITIES).
- 26. THE CONTRACTOR SHALL CLOSE ONLY ONE LANE OF TRAFFIC AT A TIME. CONTRACTOR SHALL COORDINATE ANY LANE CLOSURES WITH THE CITY OF GRETNA DEPARTMENT OF PUBLIC UTILITIES 48 HOURS BEFORE EXPECTED CLOSURE PRIOR TO COMMENCING ANY WORK.
- 27. SHEETS E1.0, E2.0, ABBREVIATIONS, SCHEDULES, DETAILS, ETC., APPLY TO ALL SHEETS UNLESS INDICATED OTHERWISE.
- 28. ALL WORK MUST BE COORDINATED AND APPROVED BY CITY OF GRETNA, INCLUDING BUT NOT LIMITED TO, FOUNDATION LOCATIONS, BOX LOCATIONS, FOUNDATION PLACEMENT, ANCHOR BOLT PLACEMENT AND ORIENTATION, CONDUIT STUB-UP LOCATIONS, UNDER-STREET BORES, BORES NEAR TREES, ETC. CONTACT RON JOHNSON, INTERIM DIRECTOR, CITY OF GRETNA DEPARTMENT OF PUBLIC WORKS 504-363-1579.
- 29. WHEN ANY PART OF A RACEWAY INSTALLATION IS TO BE CONCEALED FROM VIEW OR NOT READILY ACCESSIBLE, THE PERSON SUPERVISING AND INSTALLING THE DUCT OR RACEWAY SHALL NOTIFY CITY OF GRETNA DEPARTMENT OF PUBLIC UTILITIES AND THE ENGINEER. ANY SUCH PARTS OF THE RACEWAY INSTALLATION SHALL NOT BE CONCEALED UNTIL THEY HAVE BEEN INSPECTED AND APPROVED, PROVIDED THAT ON SUCH INSTALLATION THE CONCEALMENT OF PARTS OF THE RACEWAY MUST, AT THE DISCRETION OF THE ELECTRICAL INSPECTOR, NECESSARILY PROCEED CONTINUOUSLY.
- 30. CONTRACTOR HAS THE OPTION TO INSTALL UNDERGROUND RACEWAY VIA OPEN TRENCH CUT OR DIRECTIONAL DRILLING.
- CONTRACTOR IS RESPONSIBLE FOR LOCATING AND PROTECTING ALL EXISTING UTILITY CROSSINGS INCLUDING, BUT NOT LIMITED TO, WATER LINES, GAS LINES, SEWER LINES, DRAIN LINES, BURIED CABLES, AND EXISTING ELECTRICAL UNDERGROUND. CONTRACTOR SHALL CONTACT THE APPROPRIATE UTILITY REPRESENTATIVE FOR COORDINATION AND MUST REPORT ANY DAMAGES TO UTILITIES PRIOR TO COMMENCING ANY REPAIRS. CONTRACTOR IS RESPONSIBLE FOR REPAIR AT CONTRACTOR'S EXPENSE ANY DAMAGES TO EXISTING UTILITIES. THE CONTRACTOR SHALL VERIFY LOCATION OF UNDERGROUND PIPE LINES, CONDUITS, AND OTHER STRUCTURES BY CONTACTING OWNERS OF UNDERGROUND UTILITIES AND BY PROSPECTING IN ADVANCE OF EXCAVATION OPERATIONS. CONTACT LA ONE CALL 811 OR 800 272-3020 FOR UTILITY LOCATIONS.
- 32. RACEWAY SHALL BE INSTALLED A MINIMUM OF 24" BELOW ALL DRIVEWAYS, 12" BELOW CONCRETE SIDEWALKS (4" THICK), AND 18" BELOW GRASS/EARTHEN AREAS.
- 33. EQUIPMENT AND FOUNDATION LOCATIONS MAY BE ADJUSTED ONLY WITH THE PERMISSION OF THE ENGINEER. THE CONTRACTOR SHALL FURNISH AS—BUILT DRAWINGS WHICH SHOW THE FINAL INSTALLED LOCATIONS.
- 34. CONTRACTOR IS RESPONSIBLE FOR THE REMOVAL AND REPLACEMENT OF ALL CONCRETE SIDEWALKS AND DRIVEWAYS NECESSARY FOR RACEWAY INSTALLATION. WHERE RACEWAYS CROSS DRIVEWAYS, CONTRACTOR HAS THE OPTION TO SAWCUT THE ENTIRE WIDTH OF CONCRETE DRIVEWAY EQUAL TO THE WIDTH OF THE SIDEWALK OR INSTALL RACEWAY VIA DIRECTIONAL DRILLING. LIMITS OF REMOVAL FOR CONCRETE PAVEMENT AND SIDEWALKS SHALL BE TO EXISTING JOINT OR REQUIRED SAW JOINT TO BE COORDINATED WITH CITY OF GRETNA DEPARTMENT OF PUBLIC UTILITIES. COST FOR ALL CONCRETE WORK AND DIRECTIONAL DRILLING SHALL BE INCLUDED IN BID.
- 35. CONTRACTOR IS RESPONSIBLE FOR RESTORING ALL SURFACES TO ORIGINAL CONDITION. CONCRETE SLABS SHALL BE EQUAL TO THAT REMOVED INCLUDING REINFORCING, CONTROL JOINTS, AND EDGING, MINIMUM THICKNESS SHALL BE 4". ANY GRASS AREAS SHALL BE RESTORED TO ORIGINAL GRADE AND SODDED.
- 36. RACEWAY INSTALLATION SHALL BE BY DIRECTIONAL DRILL/BORE WHERE THERE ARE SURFACE FEATURES THAT ARE NOT TO BE DISTURBED, INCLUDING TREES, UTILITIES, ETC. TRENCHING MAY BE USED ONLY WHERE THERE ARE NO CONFLICTS WITH SURFACE FEATURES AND UTILITIES. ALL RACEWAY INSTALLATION NEAR TREES SHALL BE BY DIRECTIONAL DRILL/BORE ONLY TO AVOID DAMAGE TO TREES. DRILL/BORE PATH AND DEPTH SHALL BE COORDINATED AND APPROVED BY PROJECT ARBORIST AND CITY OF GRETNA PRIOR TO COMMENCING WORK.
- 37. CONTRACTOR SHALL USE HAND EXCAVATION TO LOCATE UNDERGROUND UTILITIES PRIOR TO ANY EXCAVATION WORK.

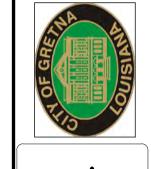

NUMBER

HUEY P. LONG AVE.


ET LIGHTING 2nd-5th Sts.



TAG NO	DTES DESCRIPTION	CATALOG VOLTAGE	LAMP
F1 1 2 3 4,	DECORATIVE TEARDROP TYPE IV POST TOP ,5 POLYCARBONATE LENS	SUN VALLEY 208-240 LCW-CPA SERIES	LED 27W
F1A 1 2 3 4,	DECORATIVE TEARDROP TYPE IV POST TOP ,6 POLYCARBONATE LENS	SUN VALLEY 208-240 LCW-CPA SERIES	LED 27W

LUMINAIRE SCHEDULE NOTES

- 1. UL LISTED AND APPROVED FOR WET LOCATIONS AT A MAXIMUM OF 40 DEGREES C AMBIENT TEMPERATURE.
- 2. LUMINARIES SHALL HAVE AN IDENTIFIED GROUNDING CONDUCTOR FROM HEAD TO POLE GROUNDING CONDUCTOR.
- 3. MOUNTING HEIGHT: 15'-0" ABOVE FINISHED GRADE.
- 4. LCW-CPA-PA-IV-48LED-175MA-40K BLACK TEXTURED FINISH.
- 5. ROUND TAPERED FLUTED ALUMINUM POLE SHAFT, WITH DECORATIVE BASE. HAPCO, VALMONT, SUN VALLEY. FURNISHED AND INSTALLED BY OWNER.
- 6. ROUND TAPERED FLUTED ALUMINUM POLE SHAFT, ASHTO COMPLIANT BREAK—AWAY COUPLINGS, WITH DECORATIVE BASE COVER TO MATCH F1 POLE. REFERENCE E4.1 FOR DETAILS. HAPCO, VALMONT, SUN VALLEY. FURNISHED AND INSTALLED BY OWNER.

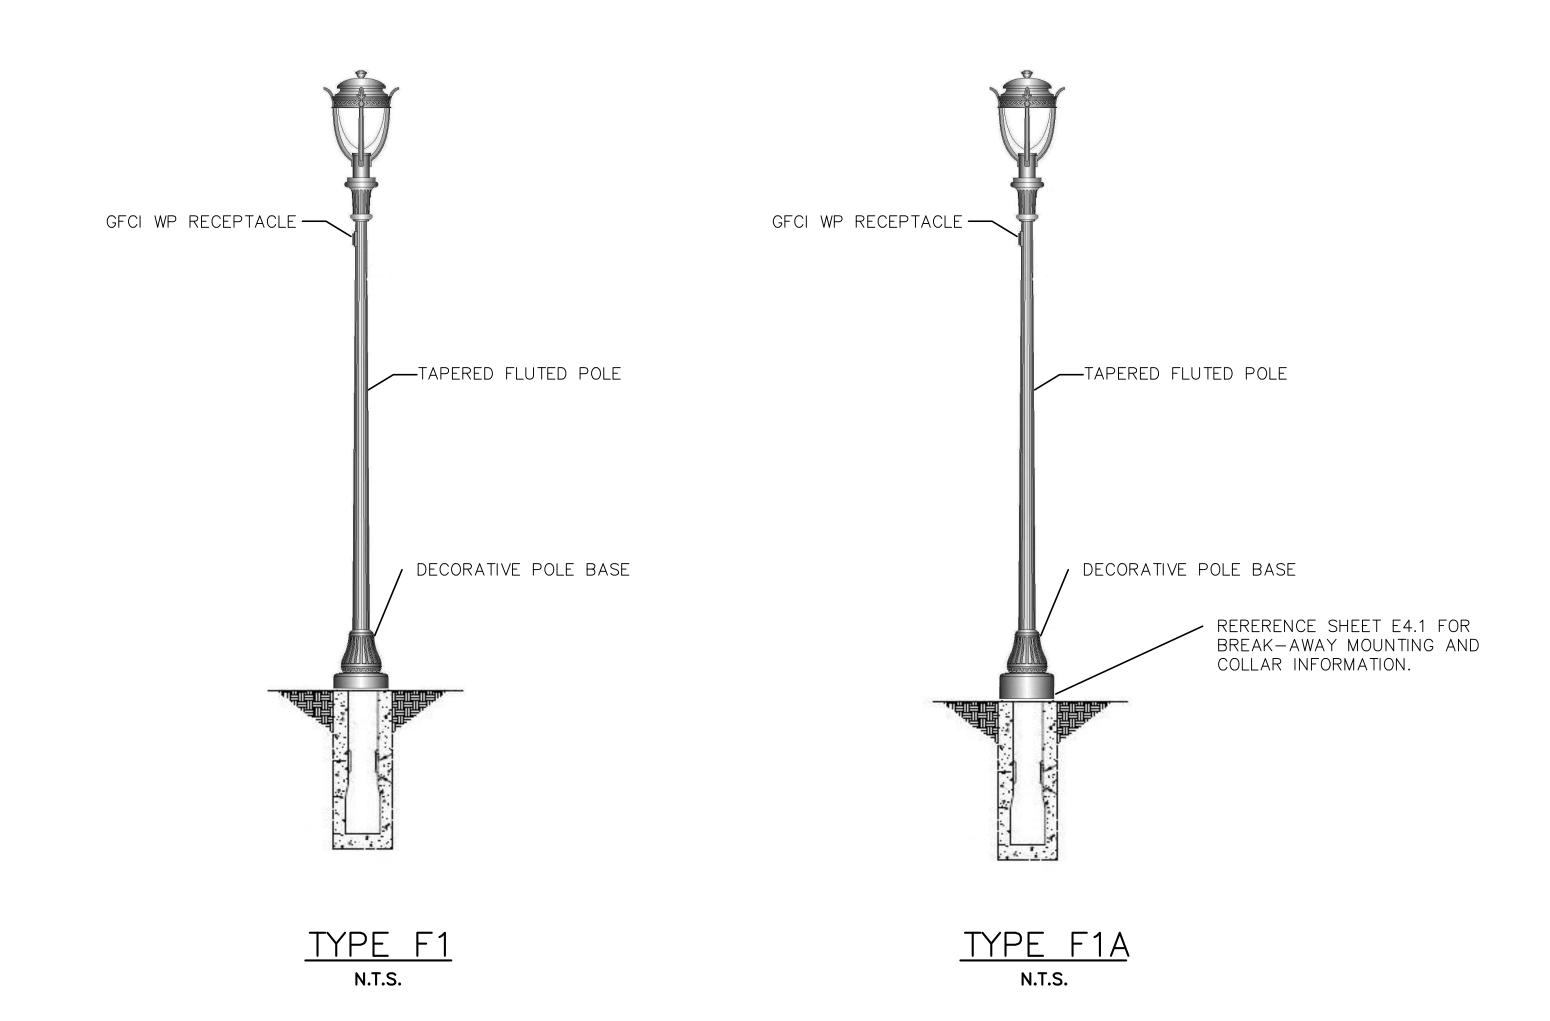

ABBREVIATIONS

	A		Н		P		\bigcup
A AFF AFG ALUM AWG	AMPERE(S) ABOVE FINISHED FLOOR ABOVE FINISHED GRADE ALUMINUM AMERICAN WIRE GAGE	HPS HID HPL JB	HIGH PRESSURE SODIUM HIGH INTENSITY DISCHARGE HUEY P. LONG AVENUE J JUNCTION BOX	P Ø PRI PVC RCPA	POLE PHASE PRIMARY POLYVINYL CHLORIDE REINFORCED CONCRETE PIPE ARCH	UG U.L.	UNDERGROUND UNDERWRITER'S LABORATORIES VOLTS
C CB CU COMM EXIST EUG	CONDUIT CATCH BASIN COPPER COMMUNICATION E EXISTING ELECTRIC UNDERGROUND	LBS. LTG. LV	POUNDS LIGHTING LOW VOLTAGE M METAL HALIDE	REC RGS SEC SFM SMH	RECEPTACLE RIGID GALVANIZED STEEL S SECONDARY SEWERAGE FORCE MAIN SEWER MAN HOLE T	W XFMR	WATTS, WIRE, WIDTH X TRANSFORMER
FT. GALV	FOOT; FEET G GALVANIZED	NEC NIC NTS	NATIONAL ELECTRICAL CODE NOT IN CONTRACT NOT TO SCALE	TELE TMH TYP	TELEPHONE TELECOMMUNICATION MANHOLE TYPICAL		



SHEET NUMBER E2.0

STREET LIGHTING 2ND TO 5TH STS.
SCHEDULES AND ABBREVIATIONS

RK-KLEINPETER, INC.
RS, ARCHITECTS, PLANNERS, ENVIRONMENTAL SCIENTISTS
OO VETERANS MEMORIAL BLVD., STE. 310
ANER, LA 70062 • PHONE (504)486-5901

ENGINEERS, 2400 KENNER BKI PROJECT NUME

DESIGNED OF CHECKED FOR CHECKE

PERRY P. HOGAN
REG. NO. 31042
REGIST RED
ROFESS ONAL ENGINEER
IN CAL ENGINEER




BURK-KLEINPETER, INC.

ENGINEERS, ARCHITECTS, PLANNERS, ENVIRONMENTAL SCIENTIST

2400 VETERANS MEMORIAL BLVD., STE. 310

KENNER, LA 70062 • PHONE (504)486-5901

STREE

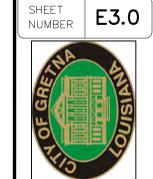

HUEY P. LONG AVE.
ET LIGHTING 2ND-5TH !
LIGHTING KEY PLAN

E3.0 E3.2

IGHTING KEY PLAN

1"= 60'

E3.0 E3.0


E3.0 E3.3

E3.0 E3.1

Concrete Driverey

HUEY P. LONG 15/99 8 37 20/11 E

(NW BOUND LANE)

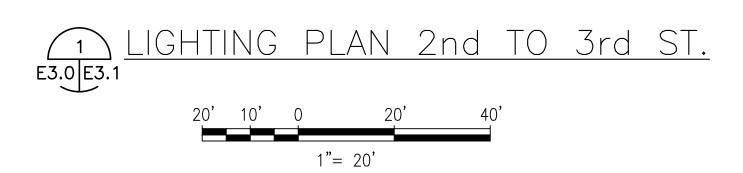

HL210 SLP1:9/11 SLP1:30 Apparent R/W STA:14+73.83

SHEET E3.1 NOTES:

- 1. PROJECT INVOLVES PLACING POLE FOUNDATIONS IN CLOSE PROXIMITY TO OVERHEAD POWER AND COMMUNICATIONS LINES AND UNDERGROUND UTILITIES. CONTRACTOR SHALL EXERCISE CAUTION AND MAINTAIN PROPER UTILITY STANDARD CLEARANCES.
- 2. UNLESS OTHERWISE STATED, PROVIDE 1" SCHEDULE 40 PVC/HDPE CONDUIT FOR UNDERGROUND LIGHTING AND RECEPTACLE CIRCUITING.
- 3. CONDUIT ROUTING AND BOX LOCATIONS ARE SCHEMATIC, ROUTING MAY BE ADJUSTED TO AVOID INTERFERENCES.
- 4. ALL TRENCHING/BORING/DRILLING WITHIN EXISTING TREE CANOPY SHALL BE COORDINATED WITH AND APPROVED BY ARBORIST PRIOR TO COMENCING ANY WORK AROUND TREES.
- 5. UNLESS NOTED OTHERWISE, PROVIDE #10 AWG COPPER CONDUCTORS FOR ALL LUMINAIRE CIRCUITS.
- 6. POLE SETBACK SHALL BE MINIMUM 2' C.L. OF POLE TO CURB.
- 7. ALL LIGHTING AND RECEPTACLE CIRCUITS SHALL BE ROUTED TO PANELBOARD VIA LIGHTING CONTROL PANEL.
- 8. REFERENCE SHEETS E4.4 FOR PANELBOARD SCHEDULE.

SHEET E3.1 SPECIFIC NOTES:

- 1) EXISTING QUAZITE PULL BOX.
- $\langle 2 \rangle$ 2 #10, 4 #6, 1 #6 GND. IN EXISTING CONDUIT.
- 31- 1 1/2"C, 2 #10, 2 #8, 2 #6, 1 #6 GND.
- **4** 1- 1 1/2"C, 2 #10, 4 #8, 1 #8 GND.
- (5) 1- 1 1/2"C, 2 #10, 4 #6, 1 #6 GND.
- 6 1- 1 1/2"C, 2 #10, 2 #6, 1 #6 GND.
- 7 1- 1 1/2"C, 2 #10, 2 #8, 1 #8 GND.
- $\langle 8 \rangle$ 2 #10, 2 #8, 2 #6, 1 #6 GND. IN EXISTING CONDUIT.
- 9>EXISTING CONDUIT.

HL214 SLP1:9/11 SLP1:30 STA:13+82.00

SCOPE OF WORK:

1. CONTRACTOR SHALL FURNISH AND INSTALL ALL POLE FOUNDATIONS, CONDUIT, PULL BOXES, AND VERIFY AND EXTEND EXISTING CONDUIT TO POLE FOUNDATIONS AND POWER CENTER. COORDINATE POWER CENTER STUB UPS WITH CITY OF GRETNA.

HL202 SLP1:9/11 SLP1:28 STA:16+51.50

Apparent R/W ____

2. CITY OF GRETNA WILL FURNISH AND INSTALL POLES, LUMINAIRES, CONDUCTORS, POWER CENTER MODIFICATIONS AND MAKE ALL TERMINATIONS.





SHEET **E3.1**


5TH AVE. 2ND HUEY P. LONG LIGHTING

URK-KLEINPETER, INC.

IEERS, ARCHITECTS, PLANNERS, ENVIRONMENTAL SCIENTIS
2400 VETERANS MEMORIAL BLVD., STE. 310
KENNER, LA 70062 • PHONE (504)486-5901

CALL BEFORE YOU DIG: Always dial 811 or 800 272-3020 first.

The call and the service are FREE.

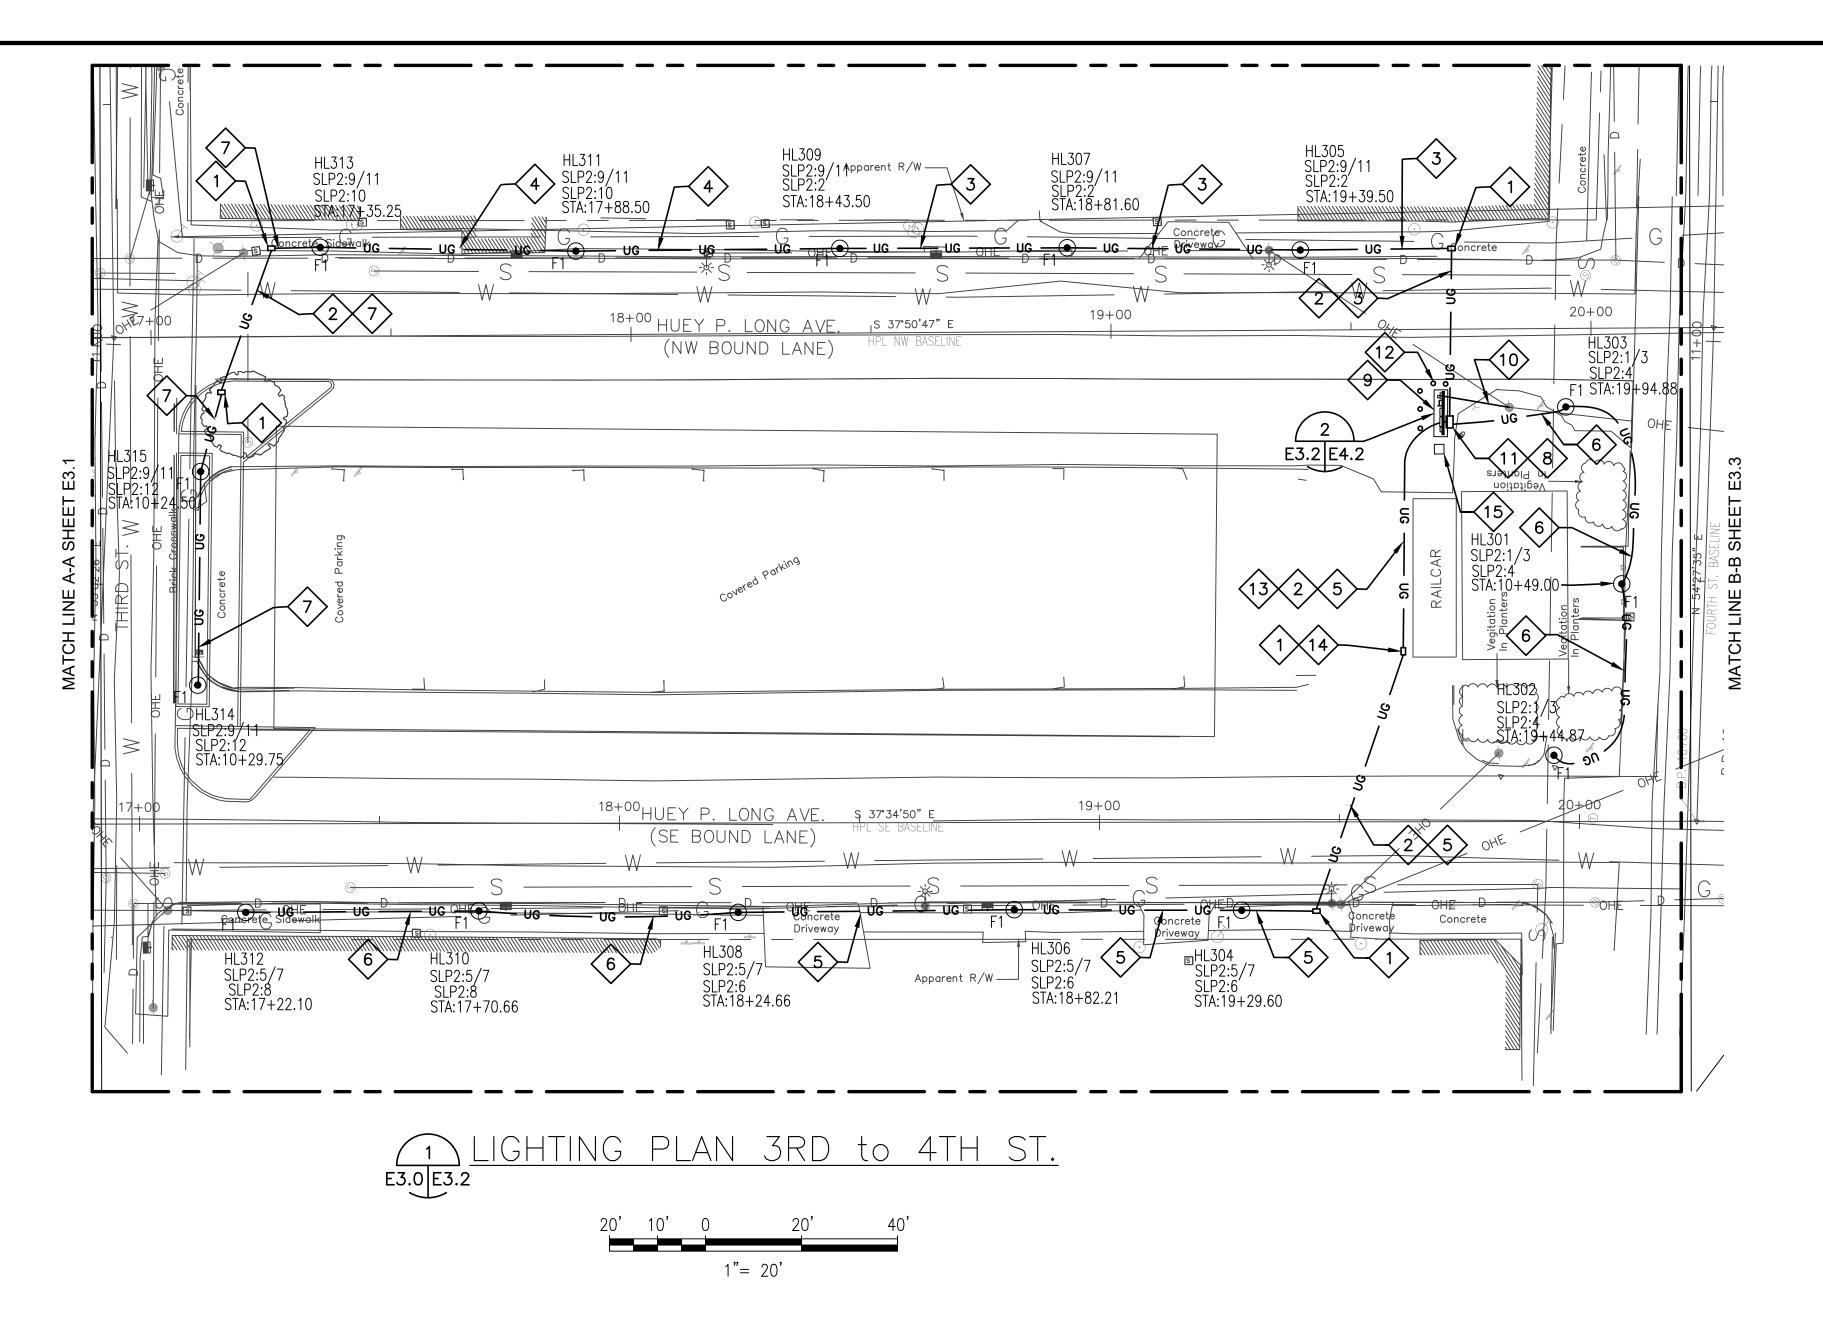

SHEET E3.2 NOTES:

- 1. PROJECT INVOLVES PLACING POLE FOUNDATIONS IN CLOSE PROXIMITY TO OVERHEAD POWER AND COMMUNICATIONS LINES AND UNDERGROUND UTILITIES. CONTRACTOR SHALL EXERCISE CAUTION AND MAINTAIN PROPER UTILITY STANDARD CLEARANCES.
- 2. UNLESS OTHERWISE STATED, PROVIDE 1" SCHEDULE 40 PVC/HDPE CONDUIT FOR UNDERGROUND LIGHTING AND RECEPTACLE CIRCUITING.
- 3. CONDUIT ROUTING AND BOX LOCATIONS ARE SCHEMATIC, ROUTING MAY BE ADJUSTED TO AVOID INTERFERENCES.
- 4. ALL TRENCHING/BORING/DRILLING WITHIN EXISTING TREE CANOPY SHALL BE COORDINATED WITH AND APPROVED BY ARBORIST PRIOR TO COMENCING ANY WORK AROUND TREES.
- 5. UNLESS NOTED OTHERWISE, PROVIDE #10 AWG COPPER CONDUCTORS FOR ALL LUMINAIRE CIRCUITS.
- 6. POLE SETBACK SHALL BE MINIMUM 2' C.L. OF POLE TO CURB.
- 7. ALL LIGHTING AND RECEPTACLE CIRCUITS SHALL BE ROUTED TO PANELBOARD VIA LIGHTING CONTROL PANEL.
- 8. REFERENCE SHEET E4.2 FOR PANELBOARD SCHEDULE.

SHEET E3.2 SPECIFIC NOTES:

- (1) PROVIDE QUAZITE 13" X 24" PG STYLE PULL BOX AT EACH END OF UNDER ROAD BORE. STUB 2" CONDUIT WITH CONDUCTORS AND 2" SPARE CONDUIT IN EACH. REFERENCE DETAIL 3/E4.0.
- $\langle 2 \rangle$ 1- 2"C EMPTY WITH PULL WIRE.
- $\langle 3 \rangle$ 1- 1 1/2"C, 2 #8, 6 #6, 1 #6 GND.
- **4** 1- 1 1/2"C, 2 #8, 4 #6, 1 #6 GND.
- $\langle 5 \rangle$ 1- 1 1/2"C, 2 #10, 4 #6, 1 #6 GND.
- 6 1- 1 1/2"C, 2 #10, 2 #6, 1 #6 GND.
- $\langle 7 \rangle$ 1- 1 1/2"C, 2 #8, 2 #6, 1 #6 GND.
- (8) CONDUITS AND CONDUCTORS TO SLP2 ROUTED THROUGH PULL BOX, PLUS TWO (2) 2" EMPTY SPARE CONDUITS WITH WITH PULL LINE.
- (9) LIGHTING CONTROL PANEL AND SERVICE PAD LOCATION. COORDINATE LOCATION AND CONDUIT STUB-UPS WITH CITY OF GRETNA.
- (10) UTILITY ELECTRICAL SERVICE FEED LOCATION. 2 1/2" SCHED. 80 PVC/HDPE CONDUIT FROM POLE TO PAD LOCATION DESIGNATED IN SPECIFIC NOTE 9. COORDINATE INSTALLATION WITH ENTERGY AND CITY OF GRETNA. CONDUIT WILL BE FURNISHED AND INSTALLED BY CONTRACTOR. CONTRACTOR SHALL COORDINATE INSTALLATION WITH CITY OF GRETNA.

- (11) PROVIDE QUAZITE 17" X 30" PG STYLE PULL BOX TO CAPTURE RACEWAY CROSSING ROAD WHERE SHOWN. STUB 2" CONDUITS WITH CONDUCTORS AND 2" SPARE CONDUITS IN EACH AS INDICATED. REFERENCE DETAIL 3/E4.0.
- (12) PROTECTIVE BOLLARDS, LOCATE PROVIDING CLEARANCE TO ELECTRICAL POWER CENTER 48" FROM FACE OF EQUIPMENT TO FACE OF BOLLARD. COORDINATE WITH CITY OF GRETNA.
- (13) LOCATE CONDUIT TRENCH TO NORTH OF EXISTING CONSTRUCTION JOINT, SAW CUTTING BROKEN CONCRETE PAVING, USING EXISTING JOINT AS SOUTH SIDE OF TRENCH.
- (14) LOCATE PULL BOX NEAR BASE OF STAIRS FROM RAILCAR.
- EXISTING PAYMENT KIOSK TO REMAIN. LOCATE POWER CENTER TO EAST OF

SCOPE OF WORK:

- CONTRACTOR SHALL FURNISH AND INSTALL ALL POLE FOUNDATIONS, CONDUIT, PULL BOXES, AND EXTEND CONDUIT TO POLE FOUNDATIONS AND POWER CENTER. COORDINATE POWER CENTER STUB UPS WITH CITY OF GRETNA.
- 2. CITY OF GRETNA WILL FURNISH AND INSTALL POLES, LUMINAIRES, CONDUCTORS, POWER CENTER (E4.2) AND MAKE ALL TERMINATIONS.




5TH AVE. 2ND HUEY P. LONG **LIGHTING** LIGHTING

URK-KLEINPETER, INC.


EERS, ARCHITECTS, PLANNERS, ENVIRONMENTAL SCIENTIS
2400 VETERANS MEMORIAL BLVD., STE. 310

KENNER, LA 70062 • PHONE (504)486-5901

CALL BEFORE YOU DIG:

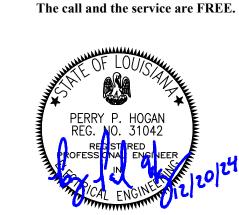

Always dial 811 or 800 272-3020 first.

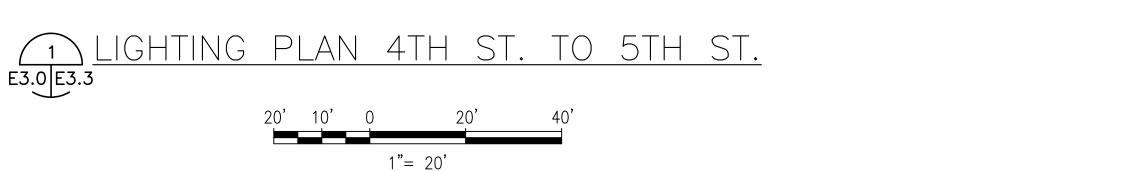

SCOPE OF WORK:

- 1. CONTRACTOR SHALL FURNISH AND INSTALL ALL POLE FOUNDATIONS, CONDUIT, PULL BOXES, AND EXTEND CONDUIT TO POLE FOUNDATIONS AND POWER CENTER. COORDINATE POWER CENTER STUB UPS WITH CITY OF GRETNA.
- 2. CITY OF GRETNA WILL FURNISH AND INSTALL POLES, LUMINAIRES, CONDUCTORS, POWER CENTER (E4.2) AND MAKE ALL TERMINATIONS.

SHEET E3.3 NOTES:

- 1. PROJECT INVOLVES PLACING POLE FOUNDATIONS IN CLOSE PROXIMITY TO OVERHEAD POWER AND COMMUNICATIONS LINES AND UNDERGROUND UTILITIES. CONTRACTOR SHALL EXERCISE CAUTION AND MAINTAIN PROPER UTILITY STANDARD CLEARANCES.
- 2. UNLESS OTHERWISE STATED, PROVIDE 1" SCHEDULE 40 PVC/HDPE CONDUIT FOR UNDERGROUND LIGHTING AND RECEPTACLE CIRCUITING.
- 3. CONDUIT ROUTING AND BOX LOCATIONS ARE SCHEMATIC, ROUTING MAY BE ADJUSTED TO AVOID INTERFERENCES.
- 4. ALL TRENCHING/BORING/DRILLING WITHIN EXISTING TREE CANOPY SHALL BE COORDINATED WITH AND APPROVED BY ARBORIST PRIOR TO COMENCING ANY WORK AROUND
- 5. UNLESS NOTED OTHERWISE, PROVIDE #10 AWG COPPER CONDUCTORS FOR ALL LUMINAIRE CIRCUITS.
- 6. POLE SETBACK SHALL BE MINIMUM 2' C.L. OF POLE TO
- 7. ALL LIGHTING AND RECEPTACLE CIRCUITS SHALL BE ROUTED TO PANELBOARD VIA LIGHTING CONTROL PANEL.

8. REFERENCE SHEET E4.3 FOR PANELBOARD SCHEDULE.

SHEET E3.3 SPECIFIC NOTES:

- PROVIDE QUAZITE 13" X 24" PG STYLE PULL BOX AT END OF UNDER ROAD BORE. STUB 2" CONDUIT WITH CONDUCTORS AND 2" SPARE CONDUIT IN EACH. REFERENCE DETAIL 3/E4.0.
- $\langle 2 \rangle$ 1- 2"C EMPTY WITH PULL WIRE.
- (3)6" SCHEDULE 80 PVC/HDPE CASING. ROUTE DESIGNATED CONDUITS THROUGH CASING. REF. E5.0 AND E5.1.
- (4)2- 2"C, 2 #10, 4 #6, 1 #6 GND. EACH CONDUIT(ROUTE PB TO PB AS SHOWN)
- $\langle 5 \rangle$ 1- 2"C, 2 #10, 4 #6, 1 #6 GND.
- $\langle 6 \rangle$ 1- 2"C, 2 #10, 2 #6, 1 #6 GND.
- $\langle 7 \rangle$ 2- 2"C, 2 #10, 4 #6, 1 #6 GND. EACH CONDUIT
- $\langle 8 \rangle$ 1- 2"C, 2 #10, 4 #6, 1 #6 GND. (ROUTE PB TO PB AS SHOWN)
- $\langle 9 \rangle$ 1- 2"C, 2 #10, 6 #6, 1 #6 GND. (ROUTE PB TO PB AS SHOWN)

- LIGHTING CONTROL PANEL AND SERVICE PAD LOCATION. COORDINATE LOCATION AND CONDUIT STUB-UPS WITH CITY OF GRETNA.
- (11) UTILITY ELECTRICAL SERVICE FEED LOCATION. 2 1/2" SCHED. 80 PVC/HDPE CONDUIT FROM POLE TO PAD LOCATION DESIGNATED IN SPECIFIC NOTE 10. COORDINATE INSTALLATION WITH ENTERGY AND CITY OF GRETNA. BORE, AND CONDUIT WILL BE FURNISHED AND INSTALLED BY CONTRACTOR. CONTRACTOR SHALL COORDINATE INSTALLATION WITH CITY OF GRETNA.
- (12) DUCT MARKER. REF. E5.0.
- PROVIDE QUAZITE 17" X 30" PG STYLE PULL BOX AT END OF UNDER ROAD BORE WHERE SHOWN. STUB 2" CONDUITS WITH CONDUCTORS AND 2" SPARE CONDUITS IN EACH AS INDICATED. REFERENCE DETAIL 3/E4.0.
- (14) CONDUITS AND CONDUCTORS TO SLP2A ROUTED THROUGH PULL BOX, PLUS TWO (2) 2" EMPTY SPARE CONDUITS WITH WITH PULL LINE.



CALL BEFORE YOU DIG: Always dial 811 or 800 272-3020 first. The call and the service are FREE.

5TH

2ND

LIGHTING

AVE.

LONG

HUEY

URK-KLEINPETER, INC

LERS, ARCHITECTS, PLANNERS, ENVIRONMENTAL SCIENTI:

Z400 VETERANS MEMORIAL BLVD., STE. 310

KENNER, LA 70062 • PHONE (504)486-5901

BK

3 TYPICAL PULL BOX AT ROAD CROSSING E4.0 E4.0 N.T.S.


INSTALLED BY OWNER - DECORATIVE BASE FURNISHED WITH POLE #6 CU RHW GROUND — - CONDUIT BUSHINGS CONDUCTOR - ANCHOR BOLTS FURNISHED BY CITY OF GRETNA INSTALLED BY CONTRACTOR. 1" CHAMFER — -POLE INSTALLATION AND LEVELING BY OWNER. TOP OF -1/2" PRE-MOLDED EXPANSION JOINT SIDEWALK ┿ 1' MIN. #6 GROUND CONDUCTOR PER MANUF. 2' MIN. 2' MIN. -CADWELD CONNECTION SCHED. 80 PVC CONDUIT STANDARD RADIUS CLASS "S" CONCRETE -COPPER WELD 5/8" X 10' GND ROD (8) #7 BARS VERTICAL— INSTALL AT ALL LOCATIONS WITH GROUND CONDUCTOR .. (EQUALLY SPACED) 6'-6" FOR 15' POLE #2 SPIRAL REINFORCEMENT (2 CLOSE TURNS AT TOP AND BOTTOM) 2'-2"

SHEET E4.0 NOTES:

- 1. FOUNDATIONS SHALL BE OF CONCRETE CAST IN PLACE. 90 DEGREE PVC SCHEDULE 80 CONDUIT RADIUS FITTINGS (QUANTITY AS SHOWN IN DETAILS) WITH BUSHING AT TOP SHALL BE PROVIDED FOR RACEWAY AND SHALL BE PLACED WITH THE RACEWAY EXTENDING FOUR INCHES (4") ABOVE THE TOP OF THE FOUNDATION, AND SHALL EXTEND SIX INCHES (6") FROM SIDES OF THE FOUNDATION, BELOW GRADE, MINIMUM TWO FEET (2') BELOW GRADE.
- 2. INSTALLERS SHALL ALWAYS EXCAVATE THE PULL BOX HOLE AT LEAST 6"-8" DEEPER THAN THE DEPTH OF THE ENCLOSURE TO ALLOW FOR THE PLACEMENT OF A MINIMUM 6" OF GRAVEL IN THE BOTTOM OF THE HOLE. THE GRAVEL BASE SHOULD EXTEND 6" BEYOND THE SIDEWALLS OF THE ENCLOSURE.

SHEET E4.0 SPECIFIC NOTES:

- QUAZITE 13" X 24" PG STYLE (STACKABLE) ASSEMBLY. OPEN BOTTOM W/2 MOUSEHOLES (PG1324BG18), WITH GASKET HEAVY DUTY TRAFFIC RATED COVER AND TWO BOLTS (PG1324HH0029), IMPRINTED "LIGHTING" ON TOP. FURNISH AS INDICATED ON PLANS.
- $\langle 2 \rangle$ raceway crossing roadways shall have at least two (2) feet OF COVER BELOW THE ROADWAY, AND TWO (2) FEET OF COVER BELOW DITCHES OR DRAINAGE STRUCTURES. BORE, CASING, AND CONDUIT UNDER STREET SHALL BE FURNISHED AND INSTALLED BY CONTRACTOR. REFERENCE SHEETS E5.0, E5.1.
- QUAZITE 17" X 30" PG STYLE (STACKABLE) ASSEMBLY. OPEN BOTTOM W/2 MOUSEHOLES (PG11730BG18), WITH GASKET HEAVY DUTY TRAFFIC RATED COVER AND TWO BOLTS (PG11730HH0029), IMPRINTED "LIGHTING" ON TOP. FURNISH AS INDICATED ON PLANS.
- PROVIDE 6" SCHED. 80 PVC/HDPE CASING UNDER ROADWAY FOR CONDUITS WHERE CASING IS INDICATED ON PLANS. REFERENCE SHEETS E5.0, E5.1 FOR ADDITIONAL DETAILS.

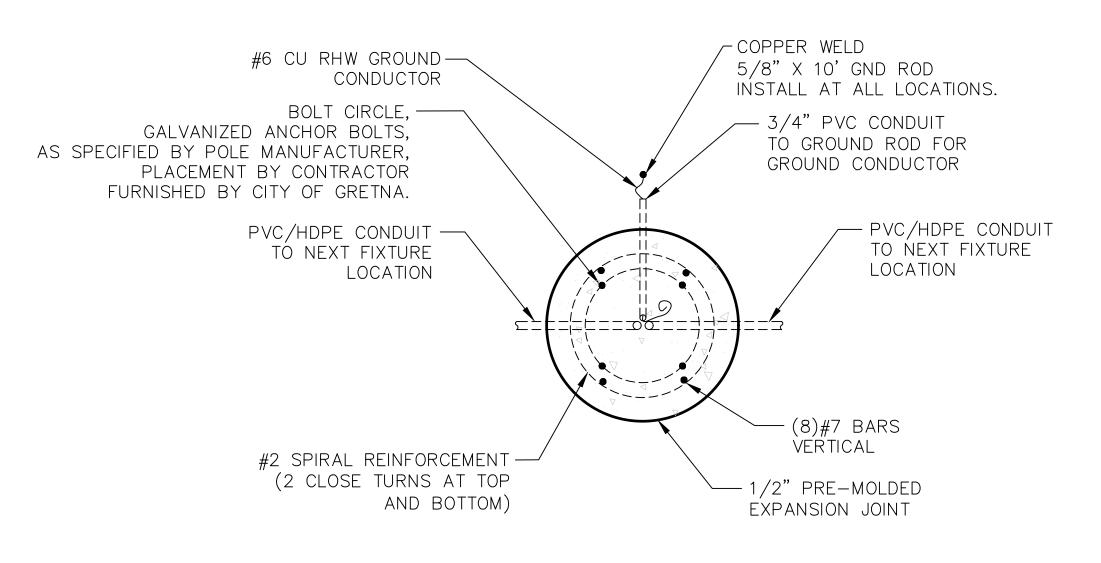

PLAN VIEW



SHEET **E4.0**

Sts.

5th

LIGHTING

RS, ARCHITECTS, PLANNERS, ENVIRONMENTAL SCIENTIS OO VETERANS MEMORIAL BLVD., STE. 310 NNER, LA 70062 • PHONE (504)486-5901

M Z

AVE.

P. LONG

DETAILS

TYPICAL

ELECTRICAL

Always dial 811 or 800 272-3020 first. The call and the service are FREE.



LIGHT POLE FURNISHED AND —

E4.0 E4.0 N.T.S.

ELEVATION VIEW 2 TYPE F1 STREET LIGHT FOUNDATION STREET LIGHT FOUNDATION E4.0 E4.0 N.T.S.

~ COPPER WELD

---3" CLR

5/8" X 10' GND ROD

TYPE F1A BASE COLLAR DETAIL E4.1 E4.1 N.T.S.


SECTION

SHEET E4.1 NOTES:

- 1. FOUNDATIONS SHALL BE OF CONCRETE CAST IN PLACE. 90 DEGREE PVC SCHEDULE 80 CONDUIT RADIUS FITTINGS (QUANTITY AS SHOWN IN DETAILS) WITH BUSHING AT TOP SHALL BE PROVIDED FOR RACEWAY AND SHALL BE PLACED WITH THE RACEWAY EXTENDING FOUR INCHES (4") ABOVE THE TOP OF THE FOUNDATION, AND SHALL EXTEND SIX INCHÉS (6") FROM SIDES OF THE FOUNDATION, BELOW GRADE, MINIMUM TWO FEET (2') BELOW GRADE.
- 2. INSTALLERS SHALL ALWAYS EXCAVATE THE PULL BOX HOLE AT LEAST 6"-8" DEEPER THAN THE DEPTH OF THE ENCLOSURE TO ALLOW FOR THE PLACEMENT OF A MINIMUM 6" OF GRAVEL IN THE BOTTOM OF THE HOLE. THE GRAVEL BASE SHOULD EXTEND 6" BEYOND THE SIDEWALLS OF THE ENCLOSURE.
- BASE COLLARS SHALL BE SHOP FABRICATED FROM TYPE 316 STAINLESS STEEL. SUBMIT SHOP DRAWINGS PRIOR TO FABRICATION. VERIFY DIMENSIONS OF POLE BASES, DIAMETER SHOWN IS FOR BID PURPOSES ONLY. FABRICATE QUANTITY REQUIRED PLUS 25% FOR SPARE REPLACEMENTS.

SHEET E4.1 SPECIFIC NOTES:

- CLIPS ARE INTENDED AS RETAINER CLIPS TO PREVENT COLLAR FROM BEING LIFTED AFTER POLES ARE INSTALLED. VERIFY DIMENSIONS WITH BREAK-AWAY HARDWARE PRIOR TO FABRICATION.
- VERIFY ALL DIMENSIONS WITH BREAK-AWAY HARDWARE AND POLE PRIOR TO FABRICATION.
- 3 QUAZITE 13" X 24" PG STYLE (STACKABLE) ASSEMBLY. OPEN BOTTOM W/2 MOUSEHOLES (PG1324BG18), WITH GASKET HEAVY DUTY TRAFFIC RATED COVER AND TWO BOLTS (PG1324HH0029), IMPRINTED "LIGHTING" ON TOP. FURNISH AS INDICATED ON PLANS.
- PROVIDE BOX AT ALL F1A POLE LOCATIONS. BOX NOT SHOWN ON PLANS FOR CLARITY.
- (5) PROVIDE TWO SETS OF BREAK-AWAY CABLES AND CONNECTORS FOR EACH POLE. ONE TO SERVE LUMINAIRE, OTHER FOR THE RECEPTACLE.
- REFERENCE SHEETS E5.0, E5.1 FOR DETAILS WITH ADDITIONAL INFORMATION REGARDING BREAK-AWAY POLE HARDWARE AND INSTALLATION REQUIREMENTS.
- (7) APPLY FIVE WRAPS PHASING TAPE NEAR END OF CABLE ON EACH. SET OF BREAK-AWAY CABLES AND CONNECTORS AT EACH POLE AND BOX. 240V LUMINAIRE YELLOW, 120V RECEPTACLE BLUE.

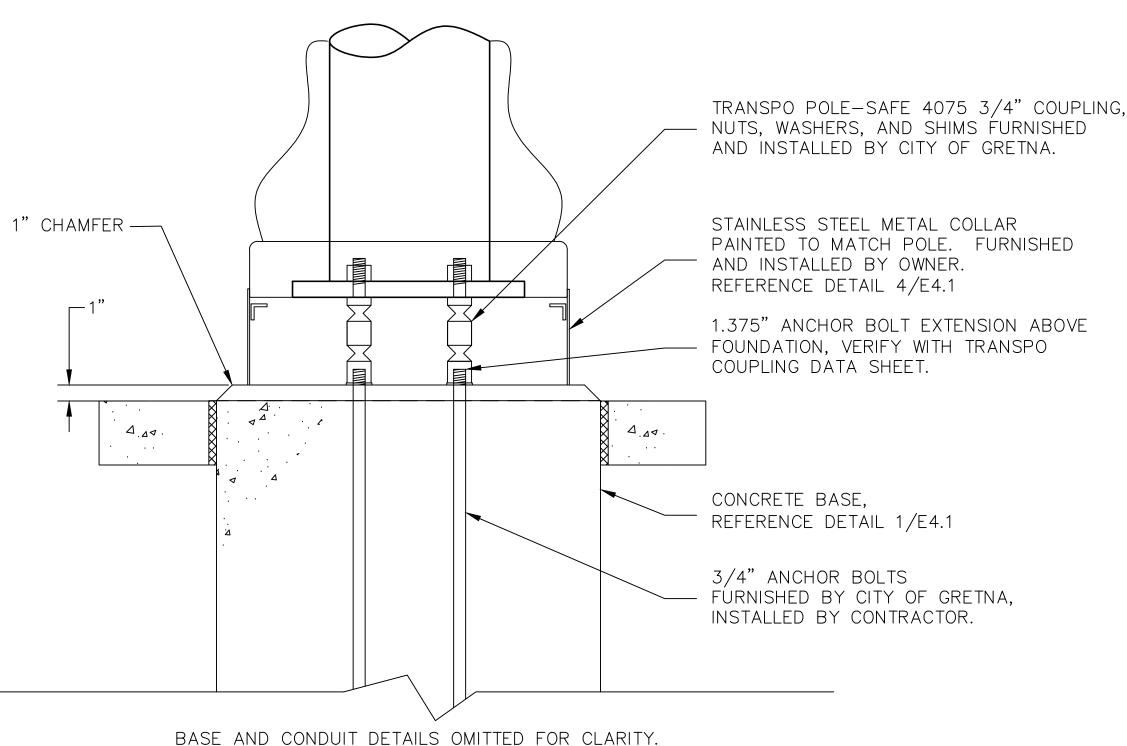

TYPE F1A FOUNDATION ANCHOR DETAIL E4.1 E4.1 N.T.S.



Always dial 811 or 800 272-3020 first. The call and the service are FREE.



RK-KLEINPETER, INC.
RS, ARCHITECTS, PLANNERS, ENVIRONMENTAL SCIENTIS
OO VETERANS MEMORIAL BLVD., STE. 310
ANER, LA 70062 • PHONE (504)486-5901

SHEET **E4.1**

Sts

5th

2nd-

LIGHTING

AVE.

P. LONG

HUEY

DETAILS

TYPICAL

ELECTRICAL



6'-6" FOR 15' POLE

CLASS "S" CONCRETE

(8) #7 BARS

(EQUALLY SPACED)

#2 SPIRAL REINFORCEMENT -


(2 CLOSE TURNS AT


TOP AND BOTTOM)

VERTICAL -

TYPE F1A STREET LIGHT FOUNDATION — ELEVATION E3.3 E4.1 N.T.S.

2'-2" ----

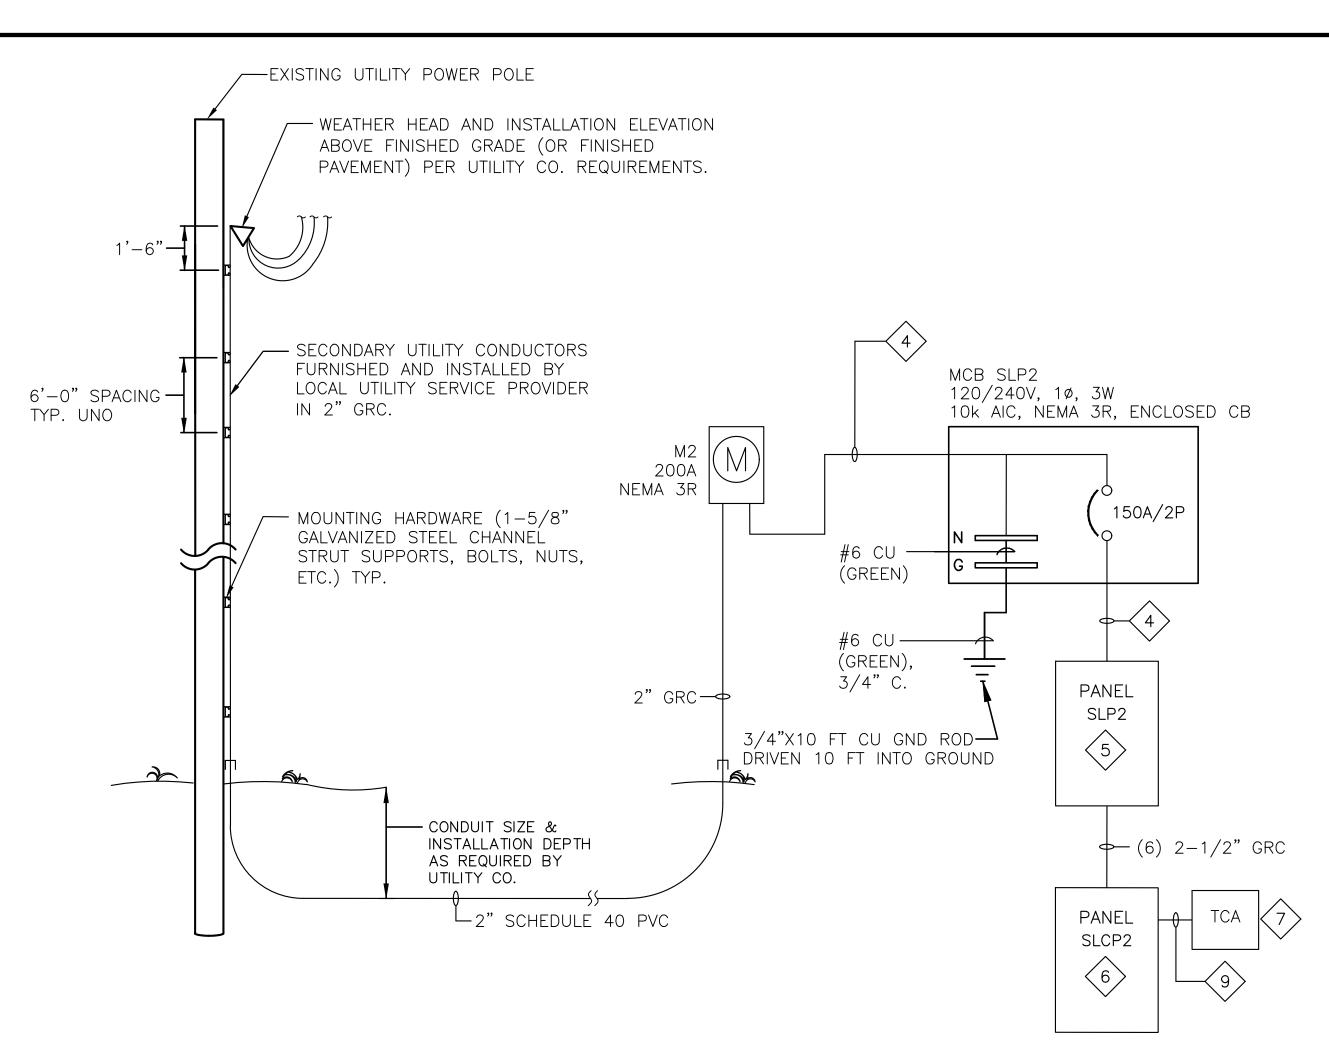

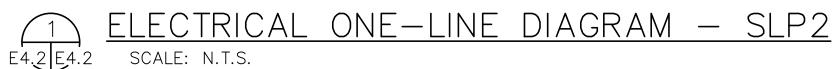



SHEET E4.2 SPECIFIC NOTES:

PAINT ALL STRUCTURAL SUPPORTS, FASTENING MATERIALS, PANELS, CANS, CONDUIT, ETC. AND ANY EXPOSED MATERIALS, COLOR AS SELECTED BY OWNER. SUBMIT SAMPLE COLOR CHIPS FOR ENGINEER AND OWNER APPROVAL. ALL EQUIPMENT (INCLUDING BUT NOT LIMITED TO ALL METER, TROUGH, PANELBOARD, CIRCUIT BREAKER, AND LIGHTING CONTROL PANEL) SHALL BE FACTORY PAINTED OR PROFESSIONALLY PAINTED WITH SUPER TGIC THERMOSET POLYESTER POWDER COAT PAINT, WITH MINIMUM OF 2 COATS PRIMER, 2 COATS RUST INHIBITOR & 2 FINAL COATS. ALL STRUCTURAL SUPPORTS, FASTENING MATERIALS, CONDUIT, ETC. SHALL BE PROFESSIONALLY PAINTED WITH SUPER TGIC THERMOSET POLYESTER POWDER COAT PAINT, WITH MINIMUM OF 2 COATS PRIMER & 2 FINAL COATS. AFTER INSTALLATION AND TESTING IS COMPLETE, ALL STRUCTURAL SUPPORTS, FASTENING MATERIALS, EQUIPMENT, CONDUIT, ETC. SHALL HAVE TOUCH-UP PAINT APPLIED TO ANY AREA WHERE THE FACTORY OR PROFESSIONAL PAINT IS DAMAGED.

- PROVIDE BLOCK OUT FOR CONDUIT INCLUDING ROOM FOR SPARES. FILL IN BLOCK OUT WITH LIGHT WEIGHT CONCRETE AFTER ALL CONDUIT HAS BEEN INSTALLED.
- <3> PAD TO BE REINFORCED 3000# PSI CONCRETE MINIMUM WITH MAXIMUM 10" DEPTH BELOW PANELS AND NO REINFORCEMENT IN CONDUIT BLOCK OUT BELOW PANELS. ALL STRUCTURAL SUPPORTS SHALL BE GALVANIZED C-CHANNEL & ANGLE ONLY AND ALL FASTENING MATERIALS SHALL BE STAINLESS STEEL NUTS, BOLTS, ETC. ONLY. CONSULT LICENSED PROFESSIONAL STRUCTURAL ENGINEER IN THE STATE OF LOUISIANA FOR DESIGN OF STRUCTURAL SUPPORTS WITH COST INCLUDED IN THIS CONTRACT.
- 3 #1/0 + #6 GROUND IN 1-1/2" RGS CONDUIT.
- $\langle 5 \rangle$ FURNISH AND INSTALL (2) 1" PVC AND (2) 2" PVC SPARE CONDUITS. CONDUITS SHALL RUN FROM PANEL AND STUB OUT 3 FEET FROM PANEL HORIZONTALLY AT MINIMUM DEPTH OF 36".

- \langle 6 angle provide basic contactor lighting control panel. Panel shall CONSIST OF NEMA 3R ENCLOSURE WITH FACTORY ASSEMBLED INTERIOR WITH TUB, COVER, AND POWER SUPPLY. PROVIDE CONTACTOR RELAYS FOR A MINIMUM OF 24 CIRCUITS/RELAYS. SYSTEM SHALL CONSIST OF RELAY PANEL, SYSTEM ASTRONOMICAL TIME CLOCK, CONTROLLER AND GROUP SWITCHING CARD. SHALL INCLUDE ALL MEETINGS WITH USER GROUP TO DEFINE SCHEDULE REQUIREMENT, ON SITE PROGRAMMING AND 2 HOUR INSTRUCTIONS. CONTRACTOR IS RESPONSIBLE FOR ALL HARDWARE, SOFTWARE, WIRING, CONDUIT, EQUIPMENT, ETC. AS REQUIRED TO PROVIDE A COMPLETE AND FUNCTIONAL LIGHTING CONTROL PANEL SYSTEM INSTALLATION WITHOUT ANY ADDITIONAL COST TO THE OWNER. FINAL EQUIPMENT OPTIONS, ACCESSORIES, CAPACITY, ETC. SHALL BE DETERMINED DURING SHOP DRAWINGS REVIEW PROCESS AT NO ADDITIONAL COSTS. LEVITON EZMAX SERIES OR APPROVED EQUIVALENT.
- PROVIDE SYSTEM ASTRONOMICAL TIME CLOCK, 8 CIRCUIT, NEMA 3R HEAVY DUTY ENCLOSURE WITH LOCKABLE HASP, 4000 EVENTS, 1 MINUTE TO 7 DAY TIME INTERVALS, 120-240V. TORK MODEL #ELC78 OR APPROVED EQUIVALENT.
- NEMA 3R HINGED COVER WIREWAY, 6" X 6" X LENGTH AS REQUIRED.
- $\langle 9 \rangle$ 6#12 + 1#12 GROUND IN 3/4" CONDUIT.
- 10 10 2" RGS CONDUITS BETWEEN SLCP2, SLP2 AND WIREWAY, 5 FOR EACH PANEL.

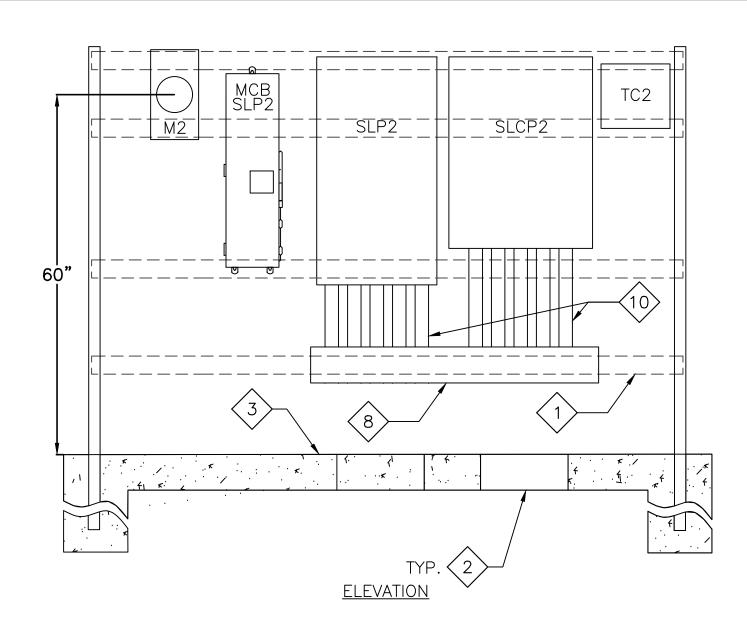

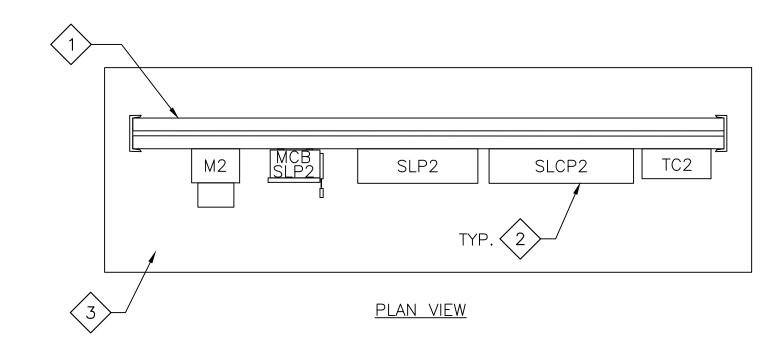



	CVT 40		NEMA 2D										22000	
	CKT 42		NEMA 3R										SYM RMS AMPS 22000	
	MAIN		SYSTEM V	OLTAGE			SCHEE	OULE OF F	PANEL				MOUNTING SURFACE	
	MLO	225	120/240 1p	h, 3wire				SLP2					LOCATION HPL @ 4TH	
CIR		CIRCUIT		C/B		KVA		PHASES		KVA		C/B	CIRCUIT	CIR
NO.	D	ESCRIPTI	ON	TRIP	POLE		Α		В		POLE	TRIP	DESCRIPTION	NO.
							4.40							
1		LIGHTING	3	20	2	0.08	1.12		4.40	1.08	1 1	20	RECEPTACLES	2
3		LIQUEING		00	0	0.44	4.45		1.12	1.08		20	RECEPTACLES	4
5		LIGHTING	j	20	2	0.14	1.15		0.70	1.08		20	RECEPTACLES	6
/		LIQUEING		00	0	0.40	0.04		0.79	0.72		20	RECEPTACLES	8
9		LIGHTING	j	20	2	0.19	0.81		0.04	0.72		20	RECEPTACLES	10
11		0D4DE			•				0.81	0.72	1	20	RECEPTACLES	12
13		SPARE		20	2							20	SPARE	14
15				00	0							20	SPARE	16
17		SPARE		20	2						1	20	SPARE	18
19		0D4DE			•							20	SPARE	20
21		SPARE		20	2							20	SPARE	22
23		0D4DE			•							20	SPARE	24
25		SPARE		20	2							20	SPARE	26
27				00	0							20	SPARE	28
29		SPARE		20	2							20	SPARE	30
31				00	0						1	20	SPARE	32
33		SPARE		20	2							20	SPARE	34
35		0D4DE			•							20	SPARE	36
37		SPARE		20	2							20	SPARE	38
39		T00			4	0.40	0.40					20	SPARE	40
41		TC2		20	1	0.10	0.10			<u> </u> 	1	20	SPARE	42
							3.18		2.72					
						ı		CONNECTED		5.91		KVA		






SHEET **E4.2**

Sts. 5th 2nd-HUEY P. LONG LIGHTING PANEL ONE-LINE,

URK-KLEINPETER, INC.

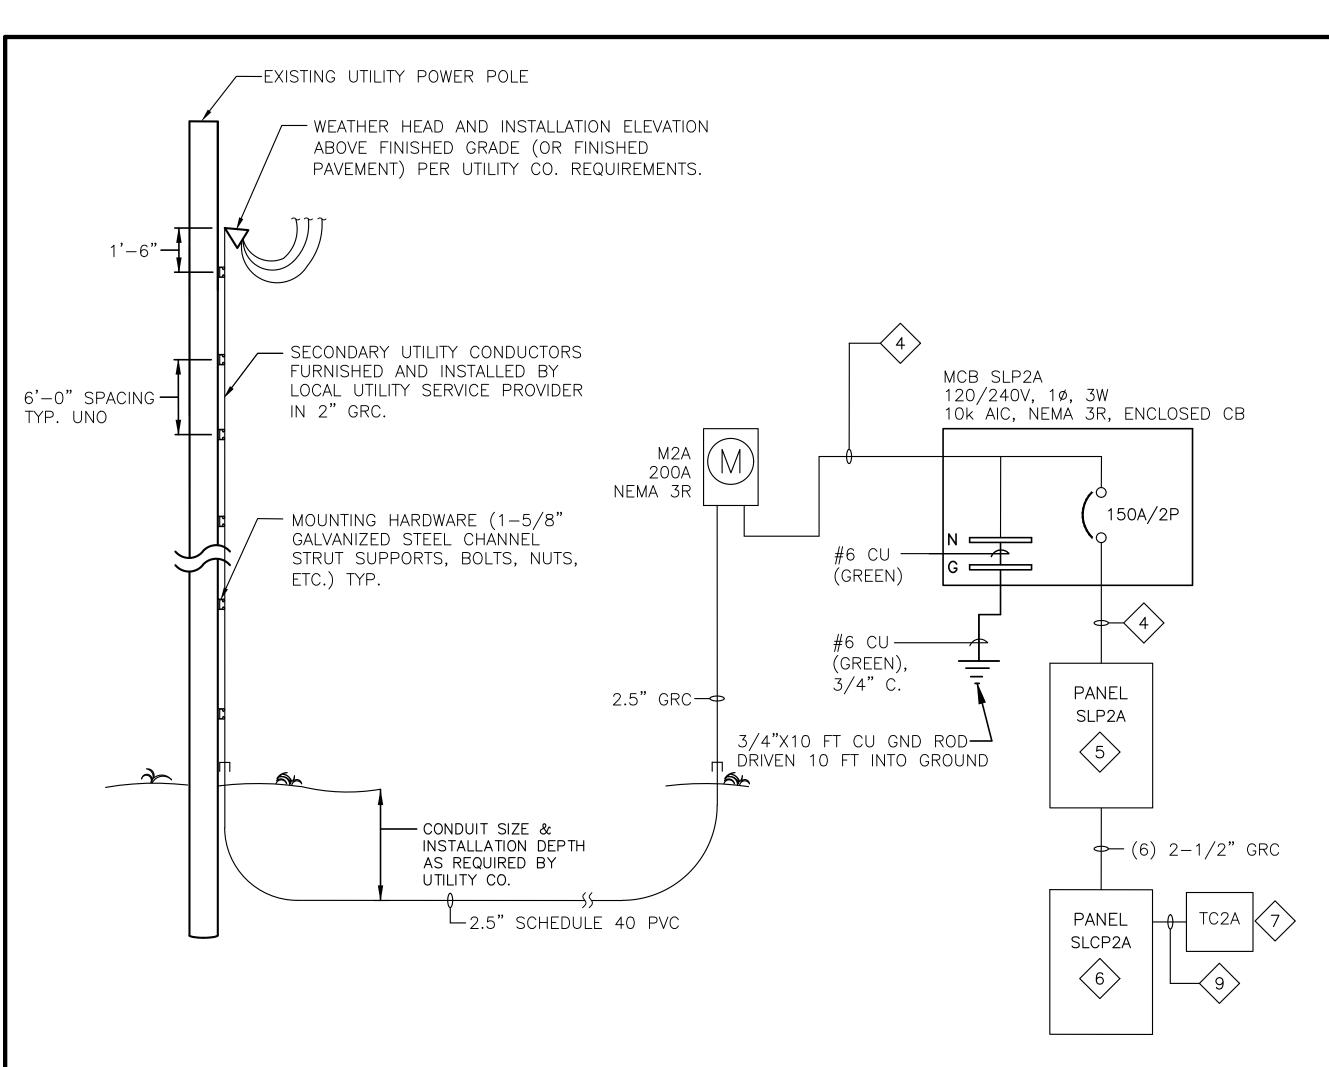





SHEET E4.3 SPECIFIC NOTES:

- PAINT ALL STRUCTURAL SUPPORTS, FASTENING MATERIALS, PANELS, CANS, CONDUIT, ETC. AND ANY EXPOSED MATERIALS, COLOR AS SELECTED BY OWNER. SUBMIT SAMPLE COLOR CHIPS FOR ENGINEER AND OWNER APPROVAL. ALL EQUIPMENT (INCLUDING BUT NOT LIMITED TO ALL METER, TROUGH, PANELBOARD, CIRCUIT BREAKER, AND LIGHTING CONTROL PANEL) SHALL BE FACTORY PAINTED OR PROFESSIONALLY PAINTED WITH SUPER TGIC THERMOSET POLYESTER POWDER COAT PAINT, WITH MINIMUM OF 2 COATS PRIMER, 2 COATS RUST INHIBITOR & 2 FINAL COATS. ALL STRUCTURAL SUPPORTS, FASTENING MATERIALS, CONDUIT, ETC. SHALL BE PROFESSIONALLY PAINTED WITH SUPER TGIC THERMOSET POLYESTER POWDER COAT PAINT, WITH MINIMUM OF 2 COATS PRIMER & 2 FINAL COATS. AFTER INSTALLATION AND TESTING IS COMPLETE, ALL STRUCTURAL SUPPORTS, FASTENING MATERIALS, EQUIPMENT, CONDUIT, ETC. SHALL HAVE TOUCH—UP PAINT APPLIED TO ANY AREA WHERE THE FACTORY OR PROFESSIONAL PAINT IS DAMAGED.
- PROVIDE BLOCK OUT FOR CONDUIT INCLUDING ROOM FOR SPARES. FILL IN BLOCK OUT WITH LIGHT WEIGHT CONCRETE AFTER ALL CONDUIT HAS BEEN INSTALLED.
- PAD TO BE REINFORCED 3000# PSI CONCRETE MINIMUM WITH MAXIMUM 10" DEPTH BELOW PANELS AND NO REINFORCEMENT IN CONDUIT BLOCK OUT BELOW PANELS. ALL STRUCTURAL SUPPORTS SHALL BE GALVANIZED C-CHANNEL & ANGLE ONLY AND ALL FASTENING MATERIALS SHALL BE STAINLESS STEEL NUTS, BOLTS, ETC. ONLY. CONSULT LICENSED PROFESSIONAL STRUCTURAL ENGINEER IN THE STATE OF LOUISIANA FOR DESIGN OF STRUCTURAL SUPPORTS WITH COST INCLUDED IN THIS CONTRACT.
- $\langle 4 \rangle$ 4 #1/0 + #6 GROUND IN 2-1/2" RGS CONDUIT.
- FURNISH AND INSTALL (2) 1" PVC AND (2) 2" PVC SPARE CONDUITS. CONDUITS SHALL RUN FROM PANEL AND STUB OUT 3 FEET FROM PANEL HORIZONTALLY AT MINIMUM DEPTH OF 36".

- PROVIDE BASIC CONTACTOR LIGHTING CONTROL PANEL. PANEL SHALL CONSIST OF NEMA 3R ENCLOSURE WITH FACTORY ASSEMBLED INTERIOR WITH TUB, COVER, AND POWER SUPPLY. PROVIDE CONTACTOR RELAYS FOR A MINIMUM OF 24 CIRCUITS/RELAYS. SYSTEM SHALL CONSIST OF RELAY PANEL, SYSTEM ASTRONOMICAL TIME CLOCK, CONTROLLER AND GROUP SWITCHING CARD. SHALL INCLUDE ALL MEETINGS WITH USER GROUP TO DEFINE SCHEDULE REQUIREMENT, ON SITE PROGRAMMING AND 2 HOUR INSTRUCTIONS. CONTRACTOR IS RESPONSIBLE FOR ALL HARDWARE, SOFTWARE, WIRING, CONDUIT, EQUIPMENT, ETC. AS REQUIRED TO PROVIDE A COMPLETE AND FUNCTIONAL LIGHTING CONTROL PANEL SYSTEM INSTALLATION WITHOUT ANY ADDITIONAL COST TO THE OWNER. FINAL EQUIPMENT OPTIONS, ACCESSORIES, CAPACITY, ETC. SHALL BE DETERMINED DURING SHOP DRAWINGS REVIEW PROCESS AT NO ADDITIONAL COSTS. LEVITON EZMAX SERIES OR APPROVED EQUIVALENT.
- PROVIDE SYSTEM ASTRONOMICAL TIME CLOCK, 8 CIRCUIT, NEMA 3R HEAVY DUTY ENCLOSURE WITH LOCKABLE HASP, 4000 EVENTS, 1 MINUTE TO 7 DAY TIME INTERVALS, 120-240V. TORK MODEL #ELC78 OR APPROVED EQUIVALENT.
- NEMA 3R HINGED COVER WIREWAY, 6" X 6" X LENGTH AS REQUIRED.
- $\langle 9 \rangle$ 6#12 + 1#12 GROUND IN 3/4" CONDUIT.
- 10 10 2" RGS CONDUITS BETWEEN SLCP2A, SLP2A AND WIREWAY, 5 FOR EAC

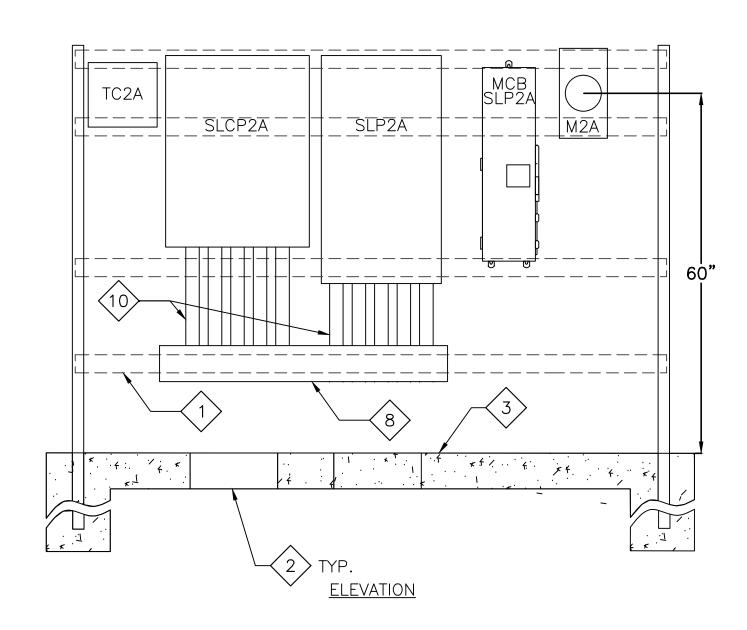

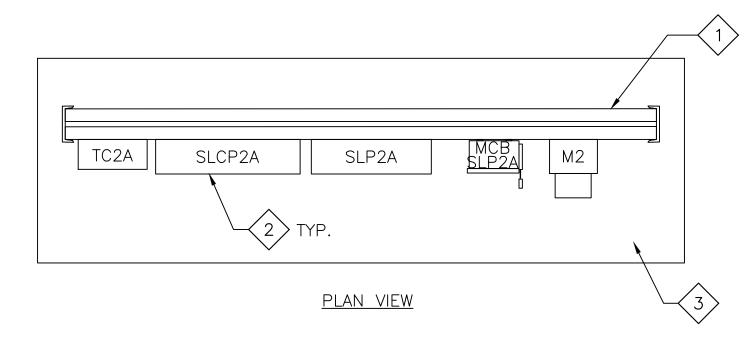



	CKT 42 NEMA 3	R									SYM RMS AMPS 22000	
I	MAIN SYSTEM	SYSTEM VOLTAGE				SCHEDULE OF PANEL					MOUNTING SURFACE	
	MLO 225 120/208 3	3ph, 4wire				SLP2A					LOCATION HPL @ 4TH	
CIR	CIRCUIT	C/B		KVA		PHASES		KVA		C/B	CIRCUIT	CIR
NO.	DESCRIPTION	TRIP	POLE		Α	В	С		POLE	TRIP	DESCRIPTION	NO.
1	LIGHTING	20	2	0.14	0.79			0.72	1	20	RECEPTACLES	2
3	LIGITING	20		0.14	0.73	1.15		1.08		20	RECEPTACLES	4
5	LIGHTING	20	2	0.14		0	0.79	0.72		20	RECEPTACLES	6
7	2.3		_	0	0.79		3 3	0.72	1	20	RECEPTACLES	8
9	LIGHTING	20	2	0.16		0.80		0.72	1 1	20	RECEPTACLES	10
11							0.80	0.72	1	20	RECEPTACLES	12
13	LIGHTING	20	2	0.19	1.17			1.08	1	20	RECEPTACLES	14
15						0.81		0.72	1	20	RECEPTACLES	16
17	SPARE	20	2				0.72	0.72	1	20	RECEPTACLES	18
19					1.08			1.08	1	20	RECEPTACLES	20
21	SPARE	20	2						1	20	SPARE	22
23									1 1	20	SPARE	24
25	SPARE	20	2						1	20	SPARE	26
27									1	20	SPARE	28
29	SPARE	20	2						1	20	SPARE	30
31									1	20	SPARE	32
33	SPARE	20	2						1	20	SPARE	34
35									1	20	SPARE	36
37	SPARE	20	2						1	20	SPARE	38
39									1	20	SPARE	40
41	TC2A	20	1	0.10			0.10	-	1	20	SPARE	42
L					3.83	2.76	2.41					
						CONNECTE		9.00		KVA		





SHEET **E4.3**

Sts. 5th AVE. 2nd-HUEY P. LONG LIGHTING PANEL ONE-LINE,

URK-KLEINPETER, INC
NEERS, ARCHITECTS, PLANNERS, ENVIRONMENTAL SCIENTI
2400 VETERANS MEMORIAL BLVD., STE. 310

4.4.DWG
-8350-E
9344-
NAME:
Ш

CKT 42	NE	MA 3R								SYM RMS AMPS 22000	
MAIN	SYS	STEM VOLTAGI	E		SCHEDUL	E OF PANEL			MOUNTING MOUNTING	;	
MLC	225 120)/240 1ph, 3wire	!		;	SLP1				LOCATION HPL @ 2ND	
CIR	CIRCUIT	C/B		KVA	Pł	IASES	KVA		C/B	CIRCUIT	CIF
10.	DESCRIPTION	TRIP	POLE		Α	В	1	POLE	TRIP	DESCRIPTION	NO
1	LIGHTING *	20	2	0.80	0.76		0.36	1 1	20	RECEPTACLES *	2
3						0.76	0.36	1 1	20	RECEPTACLES *	4
5	LIGHTING *	20	2	0.80	0.94		0.54	1	20	RECEPTACLES st	6
7						0.76	0.36	1 1	20	RECEPTACLES st	8
9	LIGHTING **	20	2	0.72	0.90		0.54	1 1	20	RECEPTACLES $*$	10
11						0.72	0.36	1	20	RECEPTACLES $*$	12
13	LIGHTING **	20	2	0.72	0.72		0.36	1 1	20	RECEPTACLES *	14
15						0.72	0.36	1	20	RECEPTACLES *	16
17	SPARE	20	2		0.36		0.36	1	20	RECEPTACLES **	18
19						0.36	0.36	1	20	RECEPTACLES **	20
21	SPARE	20	2		0.12		0.12	1	20	BOLLARD LIGHTS	22
23						0.36	0.36	1	20	RECEPTACLES	24
25	SPARE	20	2		0.36		0.36	1	20	RECEPTACLES	26
27						0.36	0.36	1	20	RECEPTACLES	28
29	SPARE	20	2		0.36		0.36	1	20	RECEPTACLES	30
31						0.36	0.36	1	20	RECEPTACLES	32
33	SPARE	20	2		0.36		0.36	1	20	RECEPTACLES	34
35								1	20	SPARE	36
37	SPARE	20	2					1	20	SPARE	38
39								1	20	SPARE	40
41	SPARE	20	1				_	1	20	SPARE	42
					4.88	4.40					_
				'	TOTAL KVA CON	INECTED:	9.28		KVA		



SHEET E4.4 SPECIFIC NOTES:

- 1. PANEL SLP1 IS EXISTING FURNISHED AND INSTALLED UNDER SEPARATE CONTRACT.
- 2. ASTERISK (*) INDICATES EXISTING CIRCUITS.
- 3. DOUBLE ASTERISK (**) INDICATES EXISTING CIRCUIT WITH ADDITIONAL LOAD.

PERRY P. HOGAN REG. NO. 31042 REGST RED ROFESS CHAIL ENGINEER		
PERRY P. HOGAN REG. NO. 31042 REDISTIRED PROFESSIONAL ENGINEER		
3376		


HUEY P. LONG AVE. EET LIGHTING 2nd-5th ? PANEL SCHEDULE

BURK-KLEINPETER, INC.

ENGINEERS, ARCHITECTS, PLANNERS, ENVIRONMENTAL SCIENTIST
2400 VETERANS MEMORIAL BLVD., STE. 310
KENNER, LA 70062 • PHONE (504)486-5901



AND LIGHT POLE CONNECTIONS

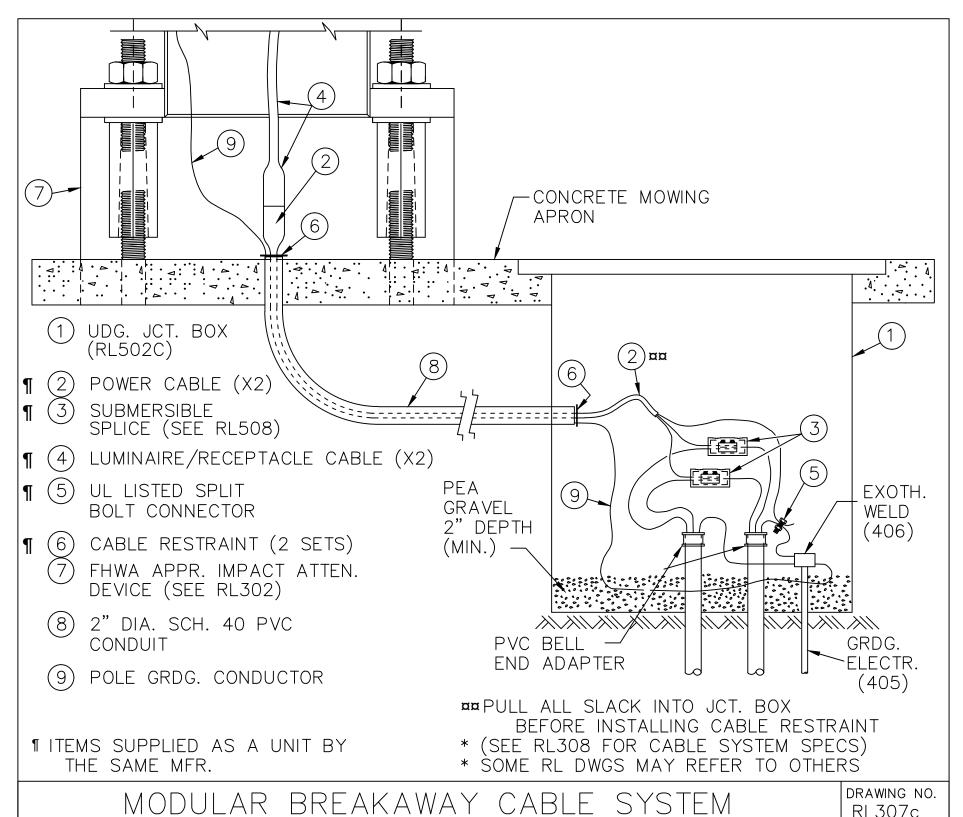

(TYPICAL; LOW MAST)

MODULAR BREAKAWAY CABLE SYSTEM

A MODULAR COLOR-CODED CABLE SYSTEM CONSISTING OF RUBBER CORDS W/ INTEGRAL MOLDED WATERTIGHT SUBMERSIBLE CONNECTORS, SUBMERSIBLE SPLICE CONNÉCTORS, AND CABLE RESTRAINTS SHALL BE INSTALLED IN THE JUNCTION BOX. THE SYSTEM SHALL PROVIDE POWER FROM THE JUNCTION BOX TO THE LUMINAIRE(S). CABLES SHALL EXTEND FROM THE JUNCTION BOX AT THE POLE BASE TO LUMINAIRE(S) AT THE TOP OF POLE. TWO (2) SUCH SYSTEM SHALL BE INSTALLED AT EACH GROUND-MOUNTED BREAKAWAY POLE INSTALLATION. POLE CABLE SYSTEM SHALL CONSIST OF THE FOLLOWING MINIMUM COMPONENTS:

POWER CABLE

RL307c

12/24

CABLE SHALL BE AN 12' 12/3 SOOW CABLE WITH MOLDED FEMALE CONNECTOR ON ONE END, ORANGE FOR RECEPTACLES, BLACK FOR LIGHTS. MALE PLUG SHALL PROVIDE A WATERTIGHT SUBMERSIBLE SEAL WHEN MATED TO FEMALE CONNECTOR. FEMALE CONNECTOR SHALL PASS THROUGH A STANDARD 2" SCHEDULE 40 PVC CONDUIT. CONTRACTOR SHALL INSTALL RETAINING STRAPS AT EACH END OF CONDUIT TO PREVENT MOVEMENT AND FORCE DISCONNECTON UPON POLE BREAKAWAY. MG2 FTP-3 OR APPROVED EQUAL.

LUMINAIRE/RECEPTACLE POLE CABLE

CABLE SHALL BE A 15' LENGTH 12/3 SOOW CABLE WITH MALE PLUG MOLDED IN ORANGE FOR RECEPTACLES, BLACK FOR LIGHTS. PLUG SHALL REQUIRE A 25 LB. (MAX.) FORCE TO MATE OR DISENGAGE FROM FEMALE CONNECTOR. WHEN ENGAGED, CONNECTION SHALL BE WATERTIGHT AND SUBMERSIBLE. MG2 MTP-3 OR APPROVED EQUAL.

CONNECTORS SHALL BE FABRICATED OF THERMOSETTING SYNTHETIC POLYMER, NON-FLAME SUPPORTING, AND SHALL REMAIN FLEXIBLE OVER A TEMPERATURE RANGE OF -40° F TO 190°F. MG2 TYPE MTP-3

> MODULAR BREAKAWAY CABLE SYSTEM (TYPICAL)

DRAWING NO. RL308 12/24




04/10

DRAWING NO.

RL501

12/09

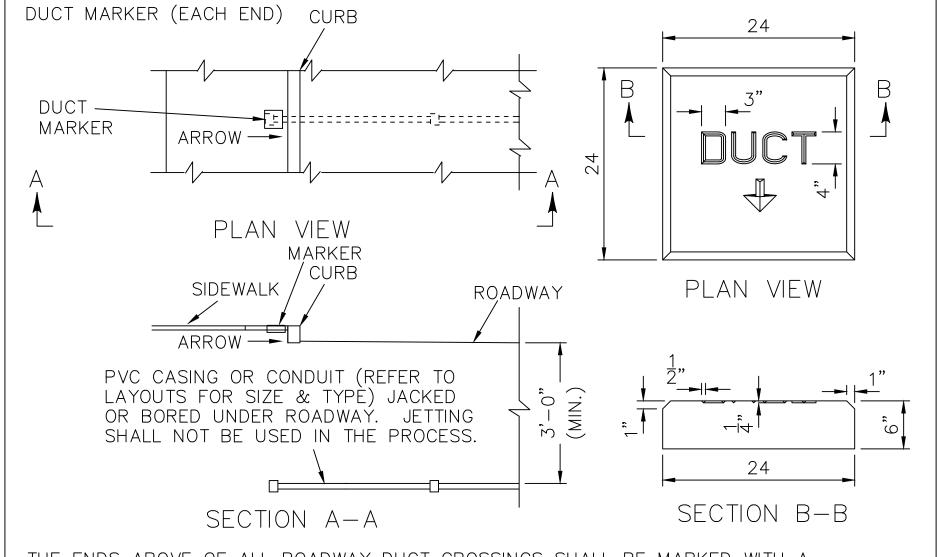

THE ENDS ABOVE OF ALL ROADWAY DUCT CROSSINGS SHALL BE MARKED WITH A CONCRETE OR POLY. CONCRETE SLAB 6" THICK BY 2 FEET SQUARE, WITH 1" BEVELED EDGES, AND 4" HIGH BY 3" WIDE LETTERS HAVING 1/2" WIDE BY 1/4" DEEP STROKE (OR AS LARGE AS THE AVAILABLE SPACE PERMITS). THÉ MARKER SLAB SHALL EXTEND APPROX. 1" ABOVE FINISHED GRADE. THE WORD "DUCT", THE NUMBER OF DUCTS BENEATH THE MARKER, THE SIZE OF EACH DUCT, AND AN ARROW INDICATING THE DIRECTION OF EACH DUCT SHALL BE IMPRESSED ON THE SURFACE OF EACH MARKER SLAB. INSTALL THE SLAB WITH THE ARROW PARALLEL AND IN THE DIRECTION OF ROADWAY DUCT CROSSING AS SHOWN ABOVE. A SUBMITTAL IS REQUIRED FOR APPROVAL PRIOR TO INSTALLATION.

UNDER ROAD CROSSING AND DUCT MARKER (TYPICAL)

SOIL WITHIN THIS AREA SHALL BE LEFT UNDISTURBED 4'-0" MIN. 4'-0" MIN. DRAINAGE PIPE NM CONDUIT (SEE LAYOUT SHEETS FOR SIZE) WHERE TOP OF DRAINAGE PIPE IS 3'-0" OR GREATER BELOW GROUND LINE, CONDUIT SHALL CROSS OVER DRAINAGE PIPE. DRAWING NO. DRAINAGE PIPE CROSSING RL501a (TYPICAL) 07/15

SHEET E5.0 NOTES:

1. DETAILS ARE TO PROVIDE ADDITIONAL INFORMATION AND SUPPLEMENT INFORMATION ELSEWHERE IN THE DRAWINGS. AND PROVIDE COMPLIANCE WITH LADOTD STANDARDS AND SPECIFICATIONS.





SHEET | E5.0

Sts DETAILS 5th AVE 2nd-LONG ٥.

TYPICAL LIGHTING ELECTRICAL HUEY

RK-KLEINPETER, INC.
RS, ARCHITECTS, PLANNERS, ENVIRONMENTAL SCIENTIS
OO VETERANS MEMORIAL BLVD., STE. 310
NEP 14 70062 • PHONE (504)486-5901

M Z

Always dial 811 or 800 272-3020 first. The call and the service are FREE.



NOTE: CONTRACTOR SHALL INSTALL CONDUITS AT AN APPROPRIATE DEPTH (3'-0") TO ACHIEVE REQUIRED VERTICAL ALIGNMENT OF CONDUITS INTO JUNCTION BOX.

UNDERGROUND JUNCTION BOX:

JUNCTION BOX SHALL BE FABRICATED FROM FIBERGLASS REINFORCED POLYMER CONCRETE OR U.V. STABILIZED HIGH-DENSITY POLYETHYLENE HAVING U.V. STABILIZED GREEN, BLACK, OR GREY COLOR. BOX SHALL BE INSTALLED IN A 6" THICK CONCRETE PAD UNLESS SHOWN OTHERWISE ON THE PLANS. BOX AND COVER SHALL BE DESIGNED FOR USE IN ROADWAY APPLICATIONS AND BE HEAVY DUTY RATED 150 PSI OVER A 10"X10" AREA (MINIMUM). ALL BOX AND COVER HARDWARE SHALL BE MARINE DUTY STAINLESS STEEL WITH A MINIMUM 30,000 P.S.I. YIELD STRENGTH. BOX COVER SHALL BE FABRICATED FROM FIBERGLASS REINFORCED POLYMER CONCRETE AND SHALL ALSO INCLUDE STANDARD "LIGHTING" LOGO. UNLESS NOTED OTHERWISE, BOX SHALL HAVE INTERIOR DIMENSIONS 12"(LENGTH) X 12"(WIDTH) X 10"(DEPTH), WITH DEPTH MEASURED FROM BOTTOM OF COVER TO BOTTOM OF BOX WHILE COVER IS INSTALLED. BOX AND COVER SHALL COMPLY WITH THREE (3) POSITION TESTING AS REQUIRED BY UNDERWRITER LABORATORIES (U.L.) ÒR WESTERN UNDERGROUND COMMITTEE (W.U.C.), GUIDELINE 3.6. FOR EQUIPMENT NOT U.L. OR W.U.C. 3.6 COMPLIANT, PROOF OF EQUIVALENT TESTING SHALL BE SUPPLIED BY A REGISTERED PROFESSIONAL ENGINEER. ALL DIMENSIONS ARE MINIMUM.

UNDERGROUND JUNCTION BOX
(TYPICAL; WITH FIBERGLASS REINFORCED POLYMER CONCRETE COVER)

DRAWING NO. RL502

04/10

HEX HEAD BOLT INSERT (OR (SEE NOJE #2) -FLOATINĞ -WITH WASHER NUT; SEE (SEE NOTE #2-3) NOTE #2-3 COVER MFR LOGO (SEE NOTE -RATING (SEE NOTE RATING (SEE POLYMER CONCRETE SURFACE COVER POLYMER CONCRETE LIFT PIN TOP VIEW (SEE NOTE #2) COVER INSERT (OR FLOATINĞ 108 17**8** NUT; SEE NOTE #2-3) -HOLE (SEE NOTE #2) SECTION B-B SECTION A-A POLYMER POLYMER CONCRETE INSERT (OR - CONCRETE FLOATINĠ COVER NUT; SEE NOTE #2-3)-DRAIN 1. ALL DIMENSIONS SHOWN ARE APPROXIMATE. REFER HOLE POLYMER TO DETAIL RL502 FOR ADDITIONAL SPECIFICATIONS. CONCRETE 2. LOCATION, SIZE, AND QTY. OF MFR. HARDWARE, LIFT NOTE #2) BOX PINS, DRAIN HOLES, LOGO, COVER RATING, ETC. MAY COVER BOLT DOWN 3. ALL HARDWARE SHALL BE MARINE DUTY STAINLESS SECTION C-C STEEL HAVING A 30,000 PSI (MIN.) YIELD STRENGTH.


UNDERGROUND JUNCTION BOX
(JB-2)

DRAWING NO. RL502c
06/07

152 HEX HEAD BOLT 14 232 WITH WASHER (SEE NOTE #2-3) — LIFT PIN LOGO (SEE NOTE #2) (SEE NOTE --NON SKID RATING SURFACE (SEE NOTE SECTION A-A SECTION B-B LOGO (SEE POLYMER NOTE #2) CONCRETE (SEE NOTE COVER MFR LOGO (SEE NOTE #2) FLOATING NUT (OR LIGHTING INSERT; SEE NOTE #2-4) -POLYMER CONCRETE COVER RATING (SEE NOTE #2) POLYMER CONCRETE BOTTOM COVER 1. ALL DIMENSIONS ARE APPROXIMATE. REFER TO DETAIL RL502 FOR ADDITIONAL SPECIFICATIONS. 2. LOCATION, SIZE, AND QUANTITY OF MFR. HARDWARE, LIFT PINS. DRAIN PLAN VIEW HOLES, LOGO, COVER RATING, ETC. MAY VARY. ALL HARDWARE SHALL BE MARINE DUTY STAIN. STEEL HAVING A 30,000 PSI (MIN.) YIELD STRENGTH. WHEN A MFR. DESIGNED INSERT IS PROVIDED, A MFR. DESIGNED DRAIN HOLE FOR EACH INSERT SHALL ALSO BE INCLUDED IN THE BOX WALL.

UNDERGROUND JUNCTION BOX

(JB-3)

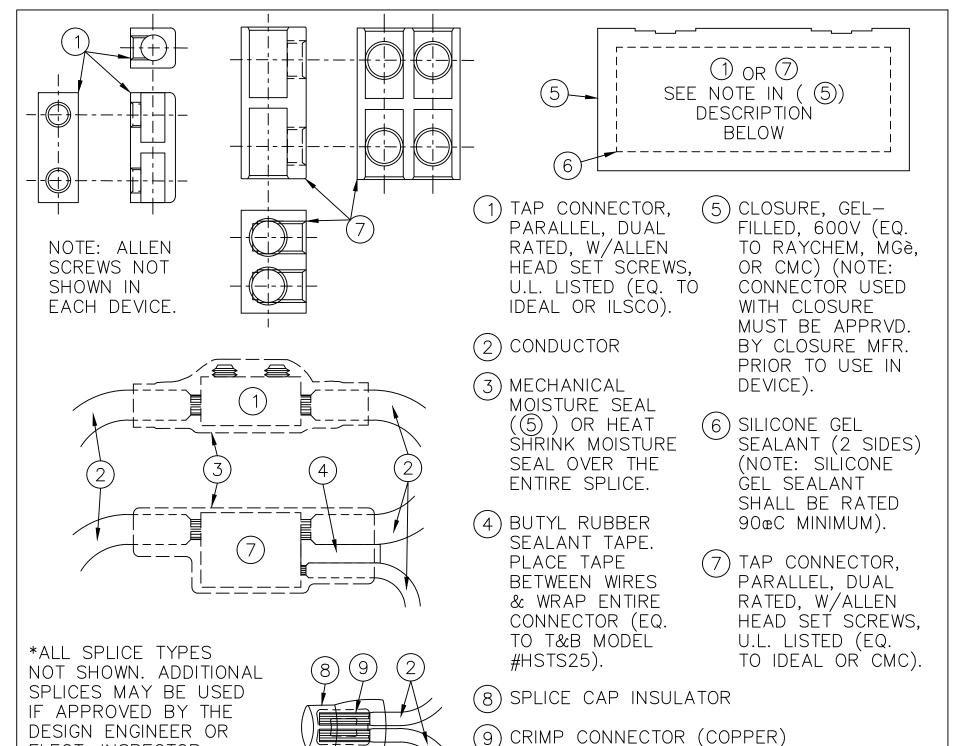

SPLICE AND TAP CONNECTOR

(TYPICAL)


DRAWING NO.

RL508

07/10

FINISHED GRADE

ELECT. INSPECTOR.

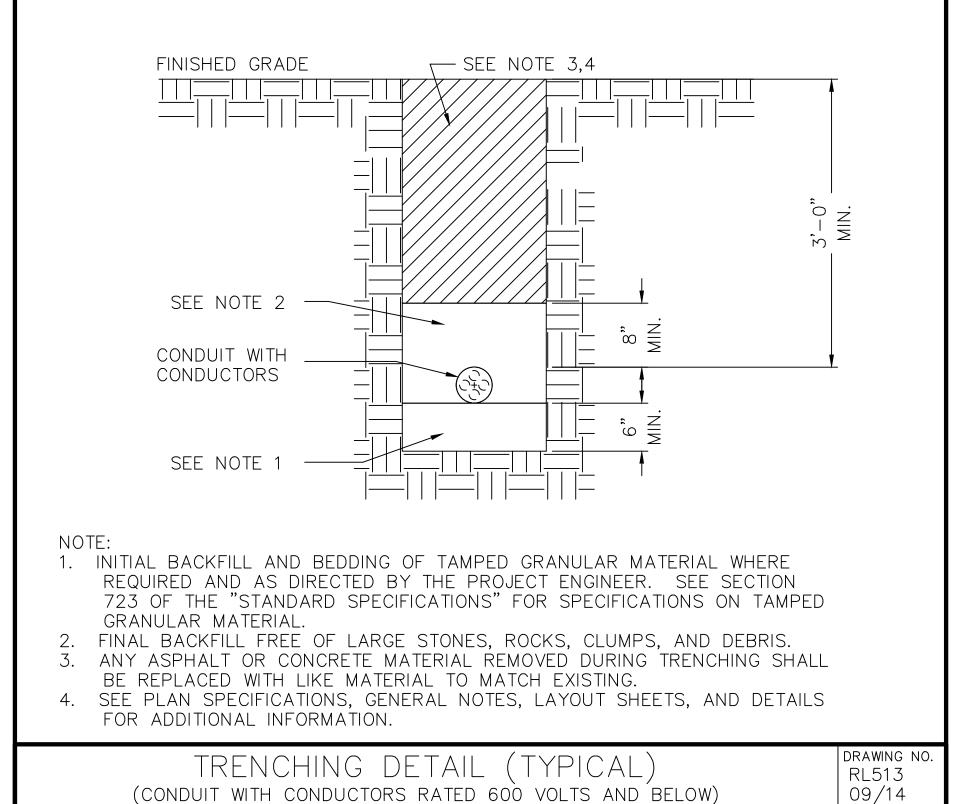

SHEET E5.1 NOTES:

1. DETAILS ARE TO PROVIDE ADDITIONAL INFORMATION AND SUPPLEMENT INFORMATION ELSEWHERE IN THE DRAWINGS, AND PROVIDE COMPLIANCE WITH LADOTD STANDARDS AND SPECIFICATIONS.





DESIGNED JBM
CHECKED PH
DETAILED JBM
CHECKED PH
DATE 12/2024
BKI PROJECT NUMBER

9344-8

NUMBER

Sts

5th

2nd-

LIGHTING

STREET

LONG

٦.

HUEY

DRAWING NO.

RL502d

06/07

DETAILS

TYPICAL

ELECTRICAL

MARKER TAPE (UNDERGROUND):

MARKER TAPE SHALL BE UDG. DETECTABLE—TYPE, SHALL BE CONSTRUCTED FROM A FLEXIBLE AND DURABLE LAMINATE HAVING HIGH-VISIBILITY. MARKER TAPE SHALL ENDURE TEMPERATURE RANGES FROM -60@F TO 250@F (MINIMUM). MARKER TAPE SHALL BE 3" OR 6" WIDE, HAVE 5 MIL (MIN.) THICKNESS, AND BE PRINTED POLYETHYLENE WITH A METALLIC CORE (OR BACKING). MARKER TAPE SHALL PROVIDE FULL LATERAL COVERAGE, REMAIN CENTERED AND IN VERTICAL ALIGNMENT 12" BELOW FINISHED GRADE, AND BE CONTINUOUS OVER THE ENTIRE LENGTH (NOTE: FOR LARGE RACEWAY CONFIGURATIONS, MORE THAN ONE (1) WIDTH OF TAPE MAY BE REQUIRED). MARKER TAPE SHALL HAVE RED COLOR AS SPECIFIED BY A.W.P.A./U.L.C.C. UNIFORM COLOR CODE FOR BURIED ELECTRIC LINES AND HAVE TWO (2) CÓNTINUOUS AND PERMANENT LINES OF PRINTED WARNING AND IDENTIFICATION IN BOLD, BLACK, BLOCK-TYPE INK OVER THE ENTIRE TAPE LENGTH. THE TOP LINE SHALL READ "CAUTION". BOTTOM LINE SHALL READ "BURIED ELECTRIC LINE BELOW". MARKER TAPE SHALL HAVE PROVEN UNDERGROUND DURABILITY, RESIST ACIDS, ALKALIS, WATER, AND BE MANUFACTURED FROM A HIGH QUALITY MATERIAL THAT MEETS OR EXCEEDS ALL INDUSTRY MINIMUM SPECIFICATIONS TO ASSURE LONG-TERM PERFORMANCE.

> MARKER TAPE (UNDERGROUND) (TYPICAL; DETECTABLE TYPE)

DRAWING NO.

RL520


05/11

LIGHTING CONTROLLERS, SWITCHBOARDS, CONTROL DESKS, DISCONNECTS, JUNCTION BOXES, GATE HOUSINGS, OTHER ENCLOSURES CONTAINING MOVABLE CONTACTS OR WIRE SIZE(S) #2 COPPER OR LARGER, AND WHERE SPECIFIED BY THE PROJECT ENGINEER SHALL BE FIELD MARKED ACCORDING TO NATIONAL ELECTRICAL CODE (N.E.C.) TO WARN QUALIFIED PERSONNEL OF THE POTENTIAL ELECTRICAL ARC FLASH HAZARDS AND DÀNGER.

LABEL(S) SHALL BE 5"X7" (MINIMUM). LABEL(S) SHALL BE MADE OF HIGH QUALITY, SELF—ADHESIVE, WATER— AND CHEMICAL RESISTANT, FLEXIBLE VINYL. LABEL(S) SHALL BE OUTDOOR RATED AND PROTECTED FROM U.V. RADIATION, MOISTURE, OXIDATION, AND OTHER POLLUTANTS. LABEL(S) SHALL BE SURFACE MOUNT AND SUITABLE FOR INSTALLING ON FLAT, ROUND OR IRREGULAR SURFÀCES OF METAL, FIBERGLASS, OR PAINT. LABEL(S) SHALL BE OVERLAMINATED WITH CLEAR FILM TO PROVIDE PRINT PROTECTION. AFFIX LABEL(S) TO ALL DOORS OF LIGHTING CONTROLLERS, CONTROL CABINETS, CONSOLES, JUNCTION BOXES CONTAINING TERMINAL BLOCKS, GATE HOUSINGS, ETC., AND WHERE SPECIFIED BY THE PROJECT ENGINEER. LABELS SHALL COMPLY WITH MIN. REQUIREMENTS SET FORTH BY OSHA 29 CFR PART 1910, NFPA 70, AND NFPA 70E. ARC FLASH PROTECTION (SEE N.E.C. 110.16). ANY VARIATIONS IN LABEL SIZE MUST BE SUBMITTED TO THE BRIDGE DESIGN ENGR. FOR APPROVAL.

LABEL "L2" LABEL "L1" ARC FLASH AND SHOCK ELECTRIC SHOCK HAZARD. HAZARD. THIS EQUIPMENT MAY BE POWERED FROM MULTIPLE APPROPRIATE PPE REQUIRED. SOURCES. FAILURE TO COMPLY CAN LOCKOUT ALL SOURCES BEFORE SERVICING. RESULT IN DEATH OR INJURY. BLACK ORANGE BACKGROUND (TYPICAL) (TYPICAL) BLACK LETTERS BLACK BACKGROUND (TYPICAL) >WHITE BACKGROUND RED BACKGROUND WHITE LETTERS -BLACK LETTERS VOLT RATING SHOWN ON "L3" MAY VARY. DRAWING NO. ELECTRICAL LABELS RL806 08/10 (TYPICAL; SELF-ADHESIVE VINYL TYPE)

WHERE SHOWN ON THE PLANS OR REQUIRED BY THE PROJECT ENGINEER, ALL LIGHTING CONTROLLERS, SWITCHBOARDS, CONTROL DESKS, DISCONNECTS, JUNCTION BOXES, GATE HOUSINGS, AND OTHER EQUIPMENT ENCLOSURES SHALL HAVE A NAMEPLATE AS SHOWN BELOW. REFER TO PLAN SHEETS AND DETAILS FOR NAME AND LOCATION. NAMEPLATE SHALL BE FABRICATED FROM " THICK (MINIMUM) PHENOL PLATE ENGRAVED STOCK. NAMEPLATE SHALL HAVE SATIN BLACK OUTER LAYER, WHITE INNER LAYER AND 45¢ BEVELED EDGES. NAMEPLATE SHALL HAVE 1" SIZE (MINIMUM) BLOCK—STYLE LETTERS AND FOUR (4) "," (MINIMUM) DIAMETER PRE-DRILLED HOLES, ONE (1) LOCATED AT EACH CORNER, FOR MOUNTING NAMEPLATE. FASTEN NAMEPLATE TO EQUIPMENT USING #6-32 (MINIMUM) MARINE DUTY STAINLESS STEEL SELF-TAPPING MACHINE SCREWS HAVING 30000 P'SI (MINIMUM) YIÉLD STRENGTH. NAMEPLATE SHALL BE LEVEL AFTER INSTALLATION. INSTALL NAMEPLATE WHERE APPLICABLE OR AS INDICATED IN THE PLANS. ANY VARIATIONS IN NAMEPLATE SIZE SHOWN BELOW MUST BE SUBMITTED TO THE BRIDGE DESIGN ENGINEER FOR APPROVAL.

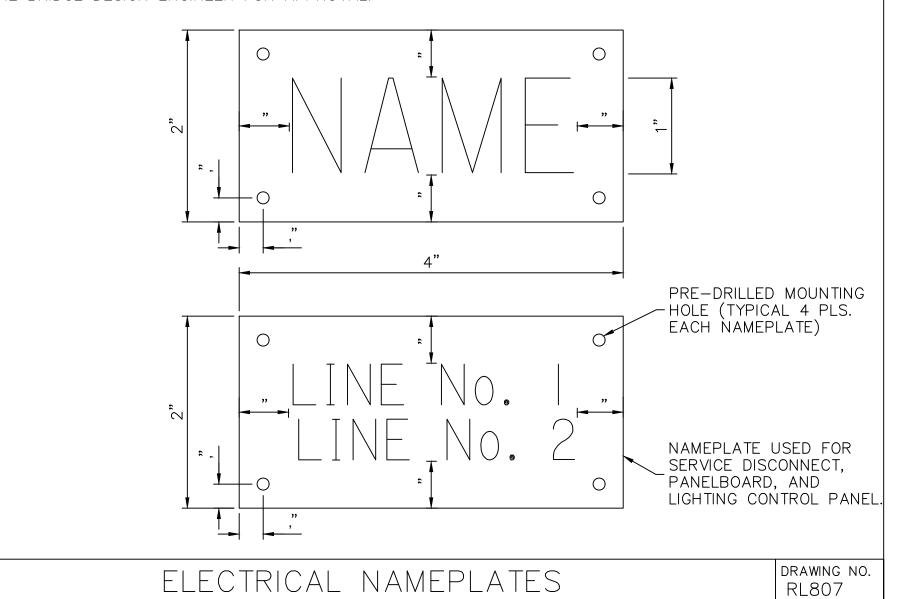

(TYPICAL; ENGRAVED PHENOL STOCK TYPE)

SHEET E5.2 NOTES:

DETAILS ARE TO PROVIDE ADDITIONAL INFORMATION AND SUPPLEMENT INFORMATION ELSEWHERE IN THE DRAWINGS, AND PROVIDE COMPLIANCE WITH LADOTD STANDARDS AND SPECIFICATIONS.



SHEET | E5.2

Sts

5th

2nd-

LIGHTING

AVE

LONG

٦.

HUEY

RK-KLEINPETER, INC.
RS, ARCHITECTS, PLANNERS, ENVIRONMENTAL SCIENTIS
OO VETERANS MEMORIAL BLVD., STE. 310
ANER, LA 70062 • PHONE (504)486-5901

04/11

DETAILS

TYPICAL

ELECTRICAL

CALL BEFORE YOU DIG: Always dial 811 or 800 272-3020 first. The call and the service are FREE.

